CONSTRUCTION NOTES

GENERAL NOTES

- 1. METHODS AND MATERIALS USED IN THE CONSTRUCTION OF THE IMPROVEMENTS HEREIN SHALL CONFORM TO THE CURRENT HOWARD COUNTY DESIGN MANUAL FOR CONSTRUCTION STANDARDS, SPECIFICATIONS, AND DETAILS AND/OR CURRENT MSHA STANDARDS AND SPECIFICATIONS.
- 2. SHAK CONSULTANTS, INC. DOES NOT CERTIFY TO THE LOCATION OR EXISTENCE OF ANY UNDERGROUND UTILITIES. THE UNDERGROUND UTILITIES SHOWN ARE FROM AVAILABLE RECORDS. THIS DOES NOT CONSTITUTE A GUARANTEE OF THEIR ACTUAL LOCATIONS OR THAT THEY HAVE ALL BEEN SHOWN. THE CONTRACTOR SHALL BE RESPONSIBLE FOR THE DIGGING OF TEST HOLES PRIOR TO BEGINNING ANY CONSTRUCTION. TEST HOLES SHALL BE MADE TO VERIFY ALL CROSSING BETWEEN NEW AND EXISTING FACILITIES AND AT CRITICAL GRADE CHANGES. IF CONDITIONS ARE FOUND IN THE FIELD WHICH ARE MATERIALLY DIFFERENT FROM THE PLANS, THE CONTRACTOR SHALL NOTIFY SHAK CONSULTANTS, INC. AND APPROPRIATE REVISIONS WILL BE MADE TO THE PLANS.
- 3. THE CONTRACTOR SHALL PROVIDE ADEQUATE MEANS OF CLEANING MUD FROM TRUCKS AND/OR OTHER EQUIPMENT PRIOR TO ENTERING THE PUBLIC RIGHT OF WAY. IT IS THE CONTRACTORS' RESPONSIBILITY TO CLEAN STREETS AND TO TAKE WHATEVER MEASURES NECESSARY TO INSURE THAT THE STREETS ARE MAINTAINED IN A CLEAN AND DUST FREE CONDITION AT ALL TIMES.
- 4. IT SHALL BE THE CONTRACTORS RESPONSIBILITY TO PERFORM THE WORK IN SUCH A MANNER TO PREVENT THE WASHING OF ANY TOP SOIL OR DEBRIS ONTO ADJACENT PROPERTIES.
- 5. ALL FINISH GRADING AND SODDING SHALL BE DONE TO PRECLUDE THE PONDING OF WATER ON THE SITE, PARTICULARLY ADJACENT TO THE BUILDING OR STORM INLETS.
- 6. THE CONTRACTOR SHALL NOTIFY "MISS UTILITY" (1-800-257-7777) AT LEAST 48 HOURS PRIOR TO ANY EXCAVATION.
- 7. THE CONTRACTOR OR DEVELOPER SHALL CONTACT THE CONSTRUCTION INSPECTION DIVISION 24 HOURS IN ADVANCED OF COMMENCEMENT OF WORK AT 313-3380.

SITE NOTES


- 1. THE PROJECT CONSISTS OF THE DEVELOPMENT OF A PARCEL OF LAND INTO A GASOLINE SERVICE STATION / QUICK SERVICE FOOD STORE.
- 2. LAND SHOWN HEREON IS PRESENTLY IN THE NAME OF RTE. 1 & 32 LIMITED PARTNERSHIP, AS RECORDED IN LIBER 913 AT FOLIO 213, LIBER 1005 AT FOLIO 34 AND LIBER 1005 AT FOLIO 37 AMONG THE LAND RECORDS OF HOWARD COUNTY, MARYLAND.
- 3. PROPERTY IS ZONED M-2 AND IS LOCATED ON HOWARD COUNTY TAX MAP 48, PARCEL 82, BLOCK 1.
- 4. SITE ADDRESS: 8755 WASHINGTON BLVD. SAVAGE, MD. 20794
- 5. BOUNTY TOPOGRAPHIC SURVEY, MERIDAN & VERTICAL DATUM WERE PREPARED BY GREINER, INC. DATED OCTOBER 2, 1989.
- 6. ROADWAY ENTRANCES ARE NOT WITHIN 200 FT. OF ANY RESIDENTIAL STRUCTURES. PUBLIC NOTICE IS NOT REQUIRED.
- 7. SOILS REPORT FOR PAVEMENT DESIGN AND FOUNDATION DESIGN WILL BE PROVIDED PRIOR TO FINAL DESIGN.

ABBREVIATIONS	LEGEND		
AC = ACRE BC = BOTTOM OF CURB BM = BENCH MARK	PROPERTY OR R/W LINES CENTER LINE		
BOW = BOTTOM OF WALL BRL = BUILDING RESTRICTION LINE	EXISTING CONTOURS	4 °£	
BS = BUILDING SUPPLIER C = CABLE	PROPOSED CONTOURS EXISTING SPOT ELEVATION	475 - 4 % * T	
CG = CURB & GUTTER CIP = CAST IRON PIPE	NEW SPOT ELEVATION	+475.33	
CL = CENTER LINE CMP = CORRUGATED METAL PIPE	EXISTING FENCE LINE	х	
CO = CLEAN OUT DIP = DUCTILE IRON PIPE	EXISTING CURB OR CURB & GUTTER PROPOSED CURB FACE & GUTTER		
E = ELECTRIC EP = EDGE OF PAVEMENT ES = END SECTION	PROPOSED CURB FACE & GUITER PROPOSED HEADER CURB FACE		
ETR = EXISTING TO REMAIN FC = FACE OF CURB	TRENCH DRAIN		
FH = FIRE HYDRANT FL = FLOW LINE	EXISTING WATER (TYP. ALL UTILS.)	······································	
G = GAS GC = GENERAL CONTRACTOR	PROPOSED WATER (TYP. ALL UTILS.) FIRE HYDRANT	TELETING TROPOSED	
HC = HANDICAPPED HP = HIGH POINT	EXISTING SANITARY SEWER		
INV = INVERT LP = LOW POINT .	PROPOSED SANITARY SEWER		
MEG = MEET EXISTING GRADE MH = MANHOLE	EXISTING STORM SEWER PROPOSED STORM SEWER		
O/H = OVERHEAD PL = PROPERTY LINE	UTILITY POLE	© EXISTING PROPOSED	
PROP = PROPOSED PVC = POLYVINYL CHLORIDE	YARD LIGHT	> PROPOSED	
PVMT = PAVEMENT RCP = REINFORCED CONCRETE PIPE	EXISTING BUILDING		
REC = REPLACE EXISTING CURB R/W = RIGHT-OF-WAY	PROPOSED BUILDING PROPOSED CANOPY		
SAN = SANITARY SEWER ST = STÖRM SEWER S/W = SIDEWALK	PROPOSED CONCRETE PAVEMENT		
T´ = TELEPHONE TC = TOP OF CURB	PROPOSED TREE	15" OAK	
TOW = TOP OF WALL U/G = UNDERGROUND UP = UTILITY POLE	EXISTING EDGE OF WOODS	Jum my	
W = WATER WM = WATER METER	EXISTING TO REMAIN	ETR	
WV = WATER VALVE	MEET EXISTING GRADE	MEG	



CENTRAL PETROLEUM CORPORATION

CROWN STATION 8755 WASHINGTON BOULEVARD ELECTION DISTRICT No. 6 HOWARD COUNTY, MARYLAND SCI NO. 92M-8551

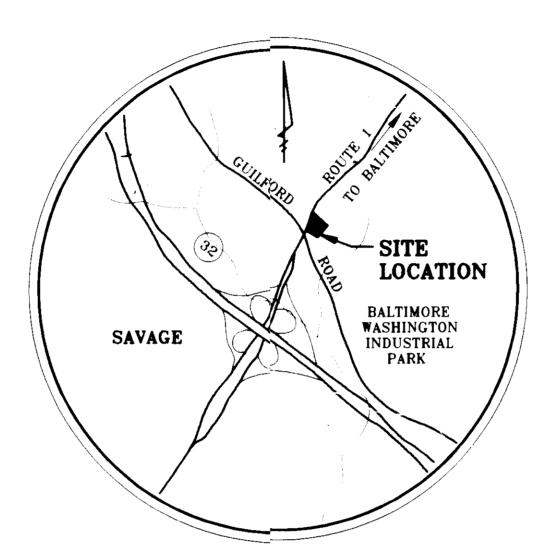

HOWARD COUNTY VICINITY MAP


SCALE: 1" = 2000'

PREPARED BY

SHAK CONSULTANTS INC.

30 NEST CUIDE DRIVE, SUITE 12 ROCKVILLE, MARYLAND 20850

(301)-294-6390 OCTOBER 6, 1992

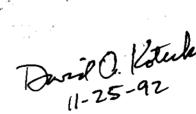


HOWARD COUNTY SDP-93-11

SUBDIVSION NAME WECHSLER PROPERTY		SECT/AREA N/A		PARCEL # A	
					PLAT #
10403	1	M-2	48	6th	6069.01
WATER CODE		I	SEWER CODE		
В)2		425	50000	

			HART	ADDRESS C			
STREET ADDRESS				EL NUMBER	PARCEL		
1	RTE.	BLVD. (U.S.	WASHINGTON	BALTIMORE	8755	A	A
_							

11-24-92

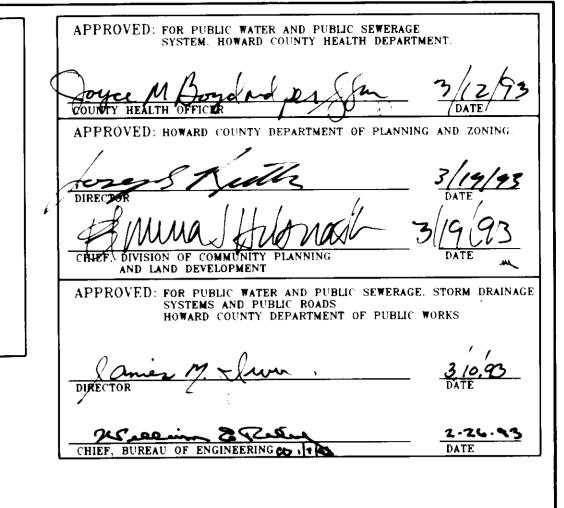

SITE PLAN SHEET INDEX

SHEET NO.	SHEET TITLE
1.)	COVER SHEET
2.)	SITE PLAN
3.)	GRADING PLAN
4.)	HORIZONTAL & VERTICAL CONTROL PLAN
5.)	RETAINING WALL DETAILS
6.)	STORM SEWER PROFILES & COMPUTATIONS
7.)	SITE DETAILS
8.)	SILTATION & SEDIMENT CONTROL PLAN
	AND DRAINAGE DIVIDE
9.)	EROSION & SEDIMENT CONTROL DETAILS
10.)	LANDSCAPE PLAN
11.)	STRUCTURAL ELEVATIONS
SITE ANALYSIS	
SITE AREA:	0.643 ACRES OR 28,026 S.F.
ZONE:	M-2
USE:	GAS STATION/CONVENIENCE STO

ORE FLOOR AREA (NET): 1345 ### S.F. UNITS - ALLOWED: – PROVIDED: NUMBER OF EMPLOYEES: SPACES PARKING - REQUIRED 11 # SPACES PROVIDED OPEN SPACE - REQUIRED: 21.78es ? PROVIDED: BUILDING GROSS FLOOR AREA: 1200 S.F. 1.470 TOTAL BUILDING COVERAGE AREA: #28 % 5.25 3080 S.F. 5.075 CANOPY AREA: 11.00 % 18.1 CANOPY COVERAGE: 438年 S.F. 6545 BUILDING AND CANOPY AREA: BUILDING AND CANOPY COVERAGE: 15.73 23.3 TOTAL LANDSCAPE AREA PROVIDED: 5524 S.F. G103.5 (INCL. 2222)
PERCENTAGE OF LANDSCAPE AREA PROVIDED: 3227 % 21.27 EXIST. TREES)

NOTES:

WP-91-112, SECTION 16.113[f8] APPROVED MAY 16, 1991 FOR NORTHERLY ACCESS POINT TO ARTERIAL HIGHWAY (F-92-160)

SPECIAL EXCEPTION (BA 90-23E) APPROVED MARCH 26, 1992 FOR
CONSTRUCTION AND OPERATION GASOLINE SERVICE STATION AND CONVENIENCE
STORE. A PETITION TO EXTEND BY (6) MONTHS, THE (3)
YEAR LIMITATION FOR SUBSTANTIAL CONSTRUCTION UNDER
PARKING TABULATION SEC 131.1.3 OF THE ZONING REQUIREMENTS
INAS APPROVED BY THE BOARD OF APPEALS,
PARKING AREA PROVIDED BY THE BOARD COUNTY ON
AREA OF LANDSCAPE ISLANDS PROVIDED OCTOBER 20, 1994; TO
WITHIN THE PARKING LOT= \$14.30 (S.F.)

WITHIN THE PARKING LOT= \$14.30 (S.F.)

SOCIOUS S.F.)

5%(6007.90 S.F.)

1995

1995

PARKING REQUIRED

1 SPACE PER EMPLOYEE 1 SPACE PER EVERY 200 S.F. OF FLOOR SPACE PARKING PROVIDED


MAXIMUM NUMBER OF EMPLOYEES = 3
3 EMPLOYEE SPACES


8 & CUSTOMER SPACES / 1345 7


(FLOOR AREA = 1350 S.F. / 200 x 1 = 8 SPACES REQD.)


1/8 TOTAL PARKING SPACES PROVIDED INCLUDING A HANDICAP SPACE.


(REV. 12-02-92 PER HOWARD CO. DPZ COMMENTS) (REV. 11-17-92 PER HOWARD CO. SRC COMMENTS) SHEET 1 OF 11
AutoCAD FILENAME: 8551CVR.DWC

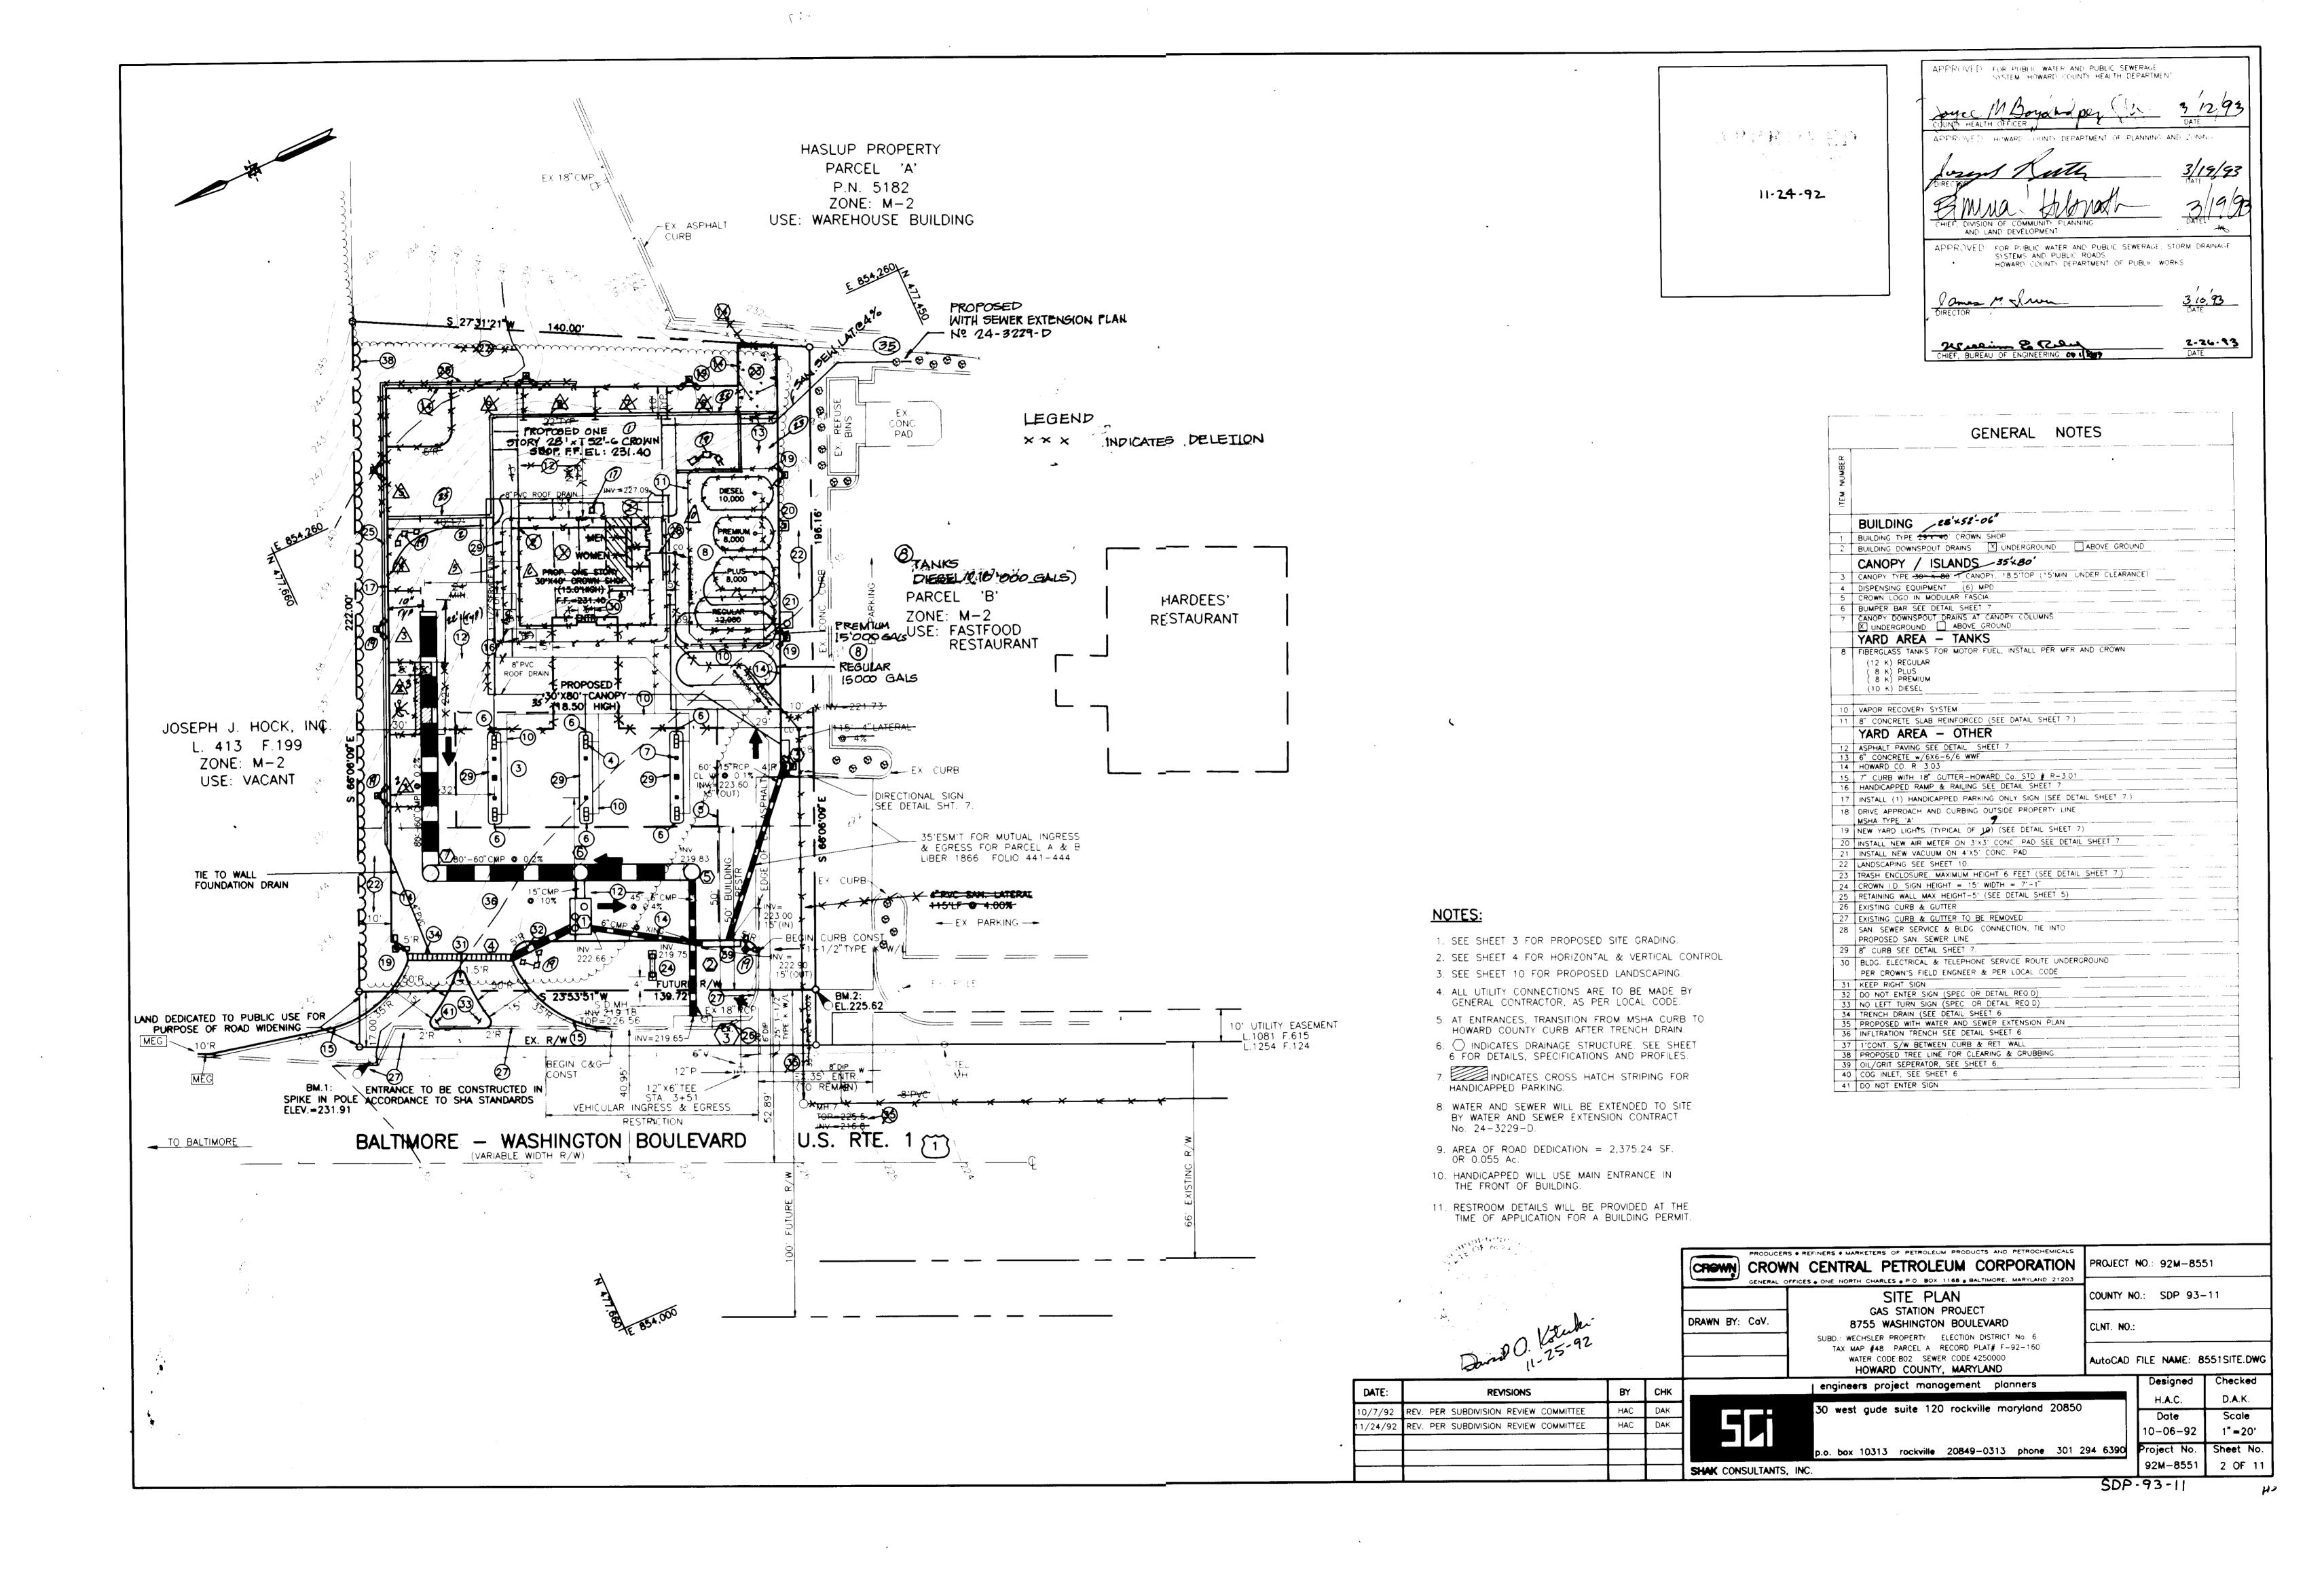


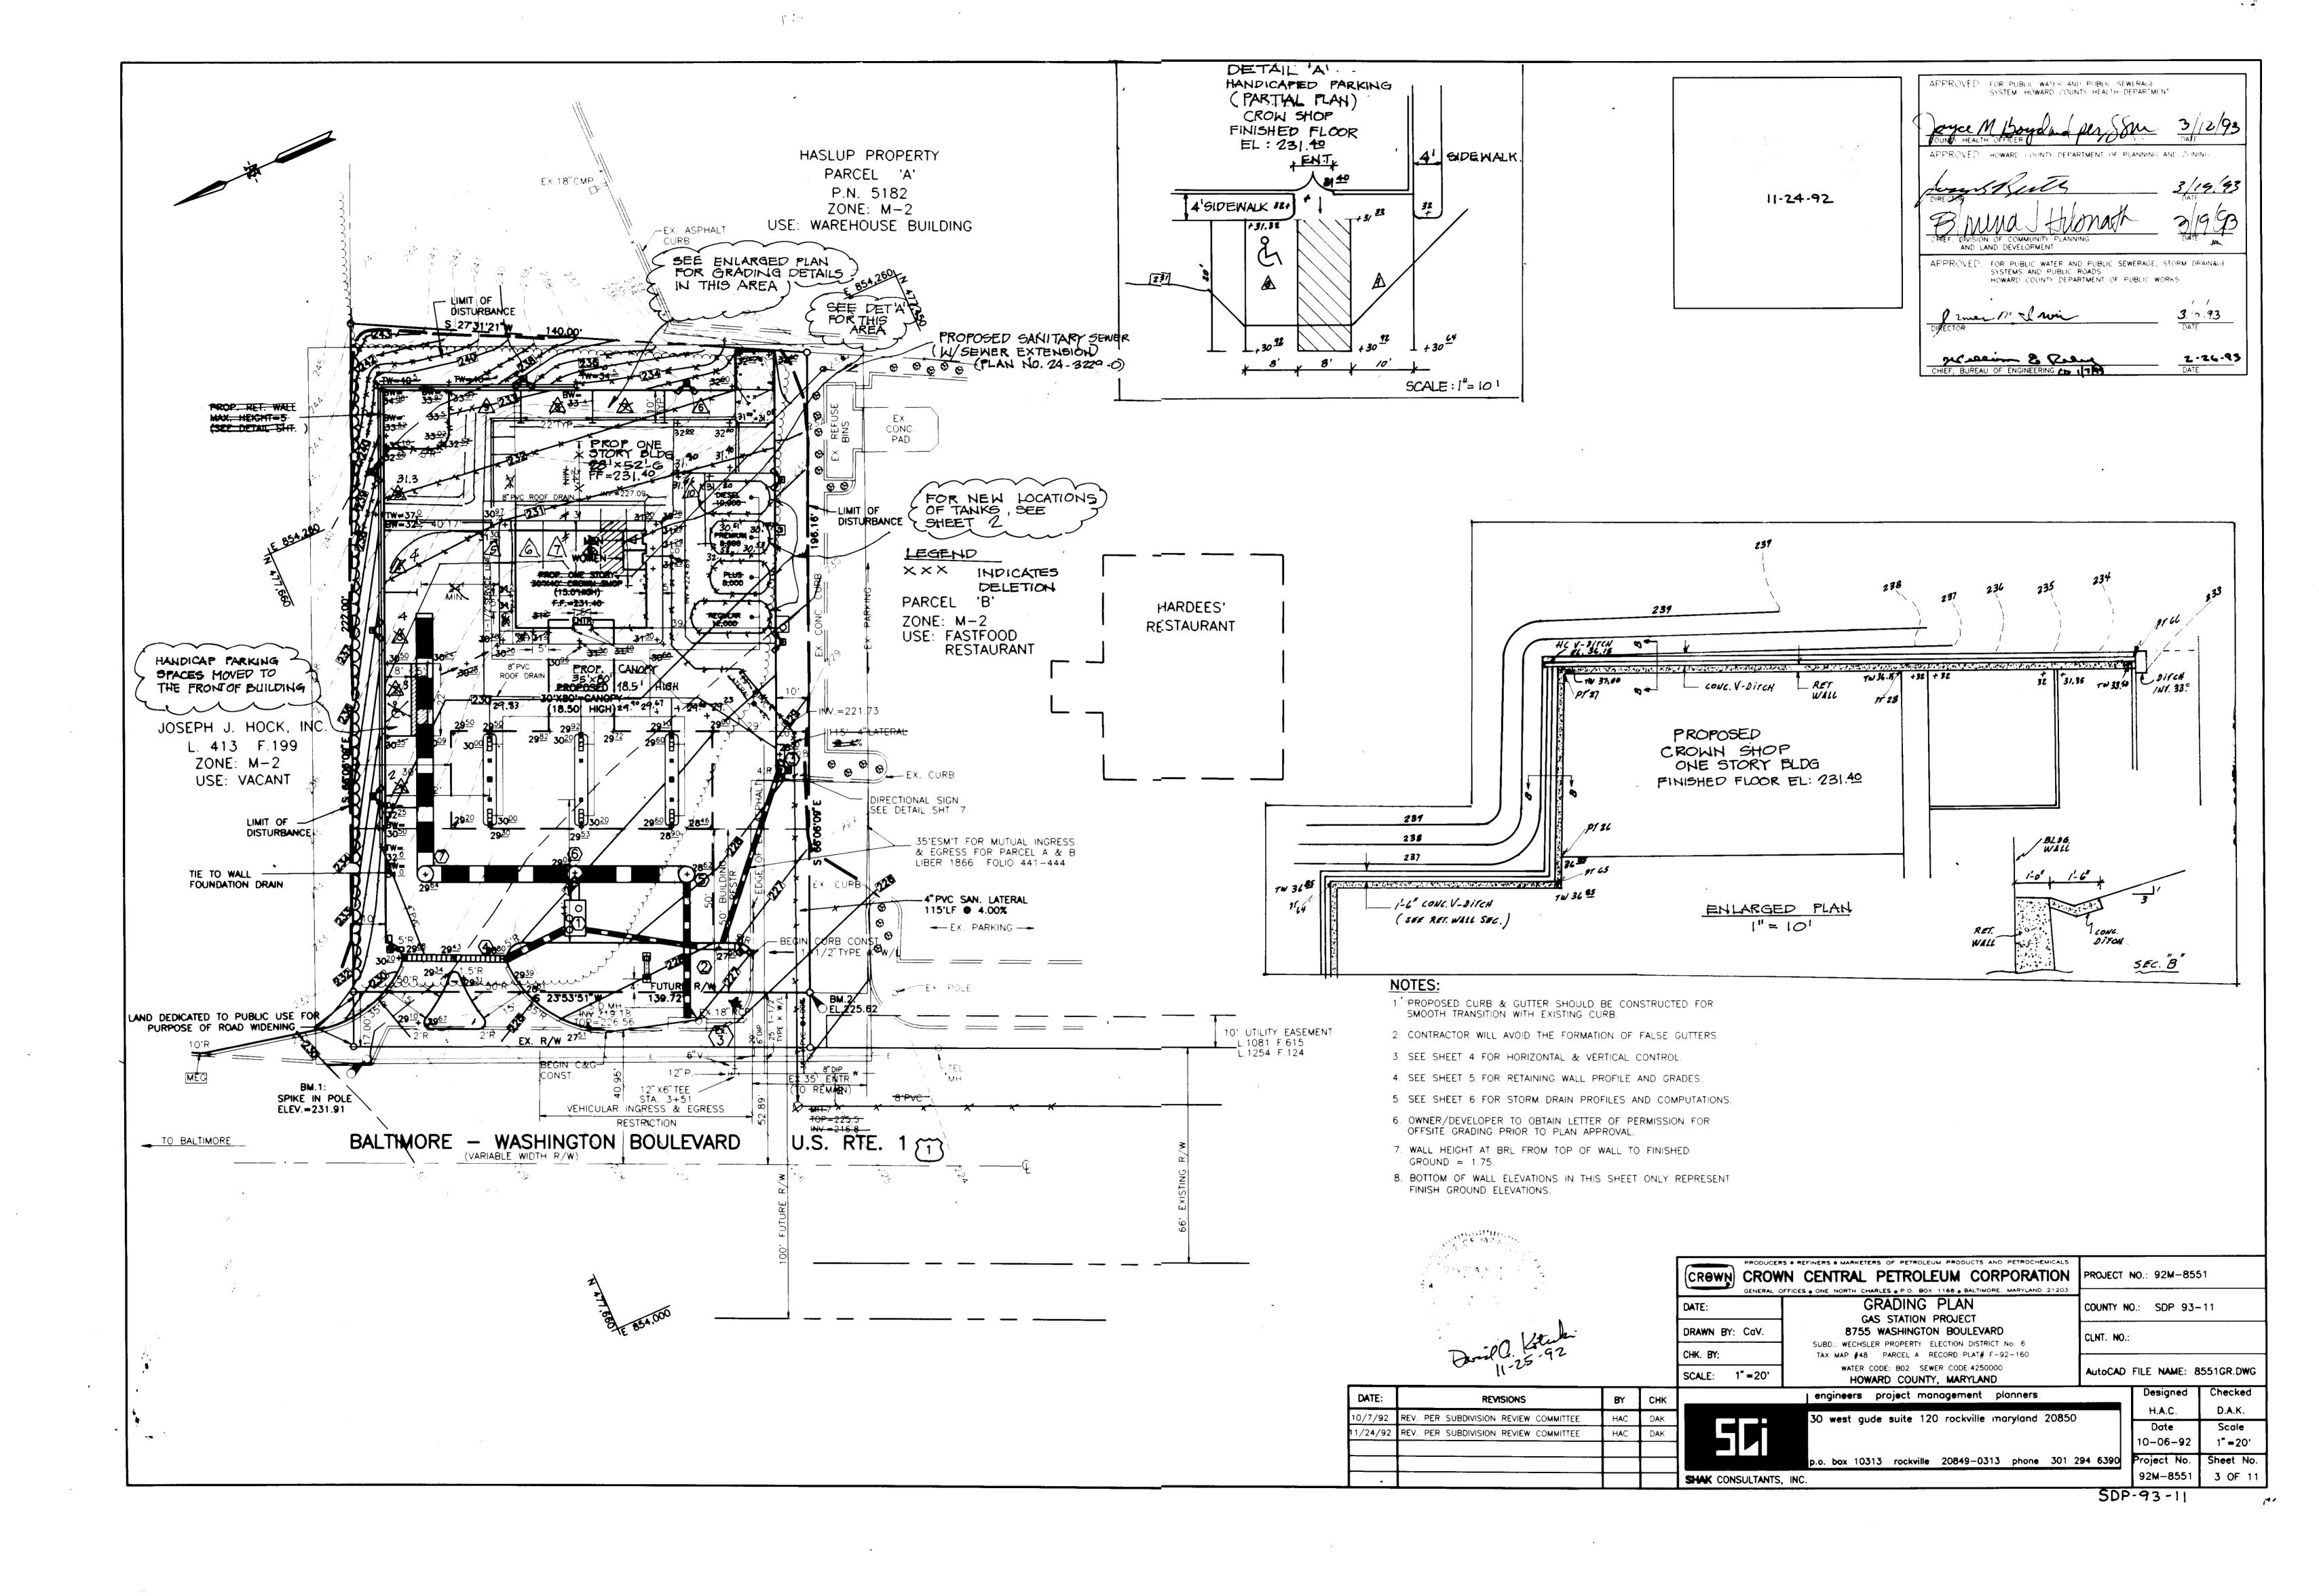


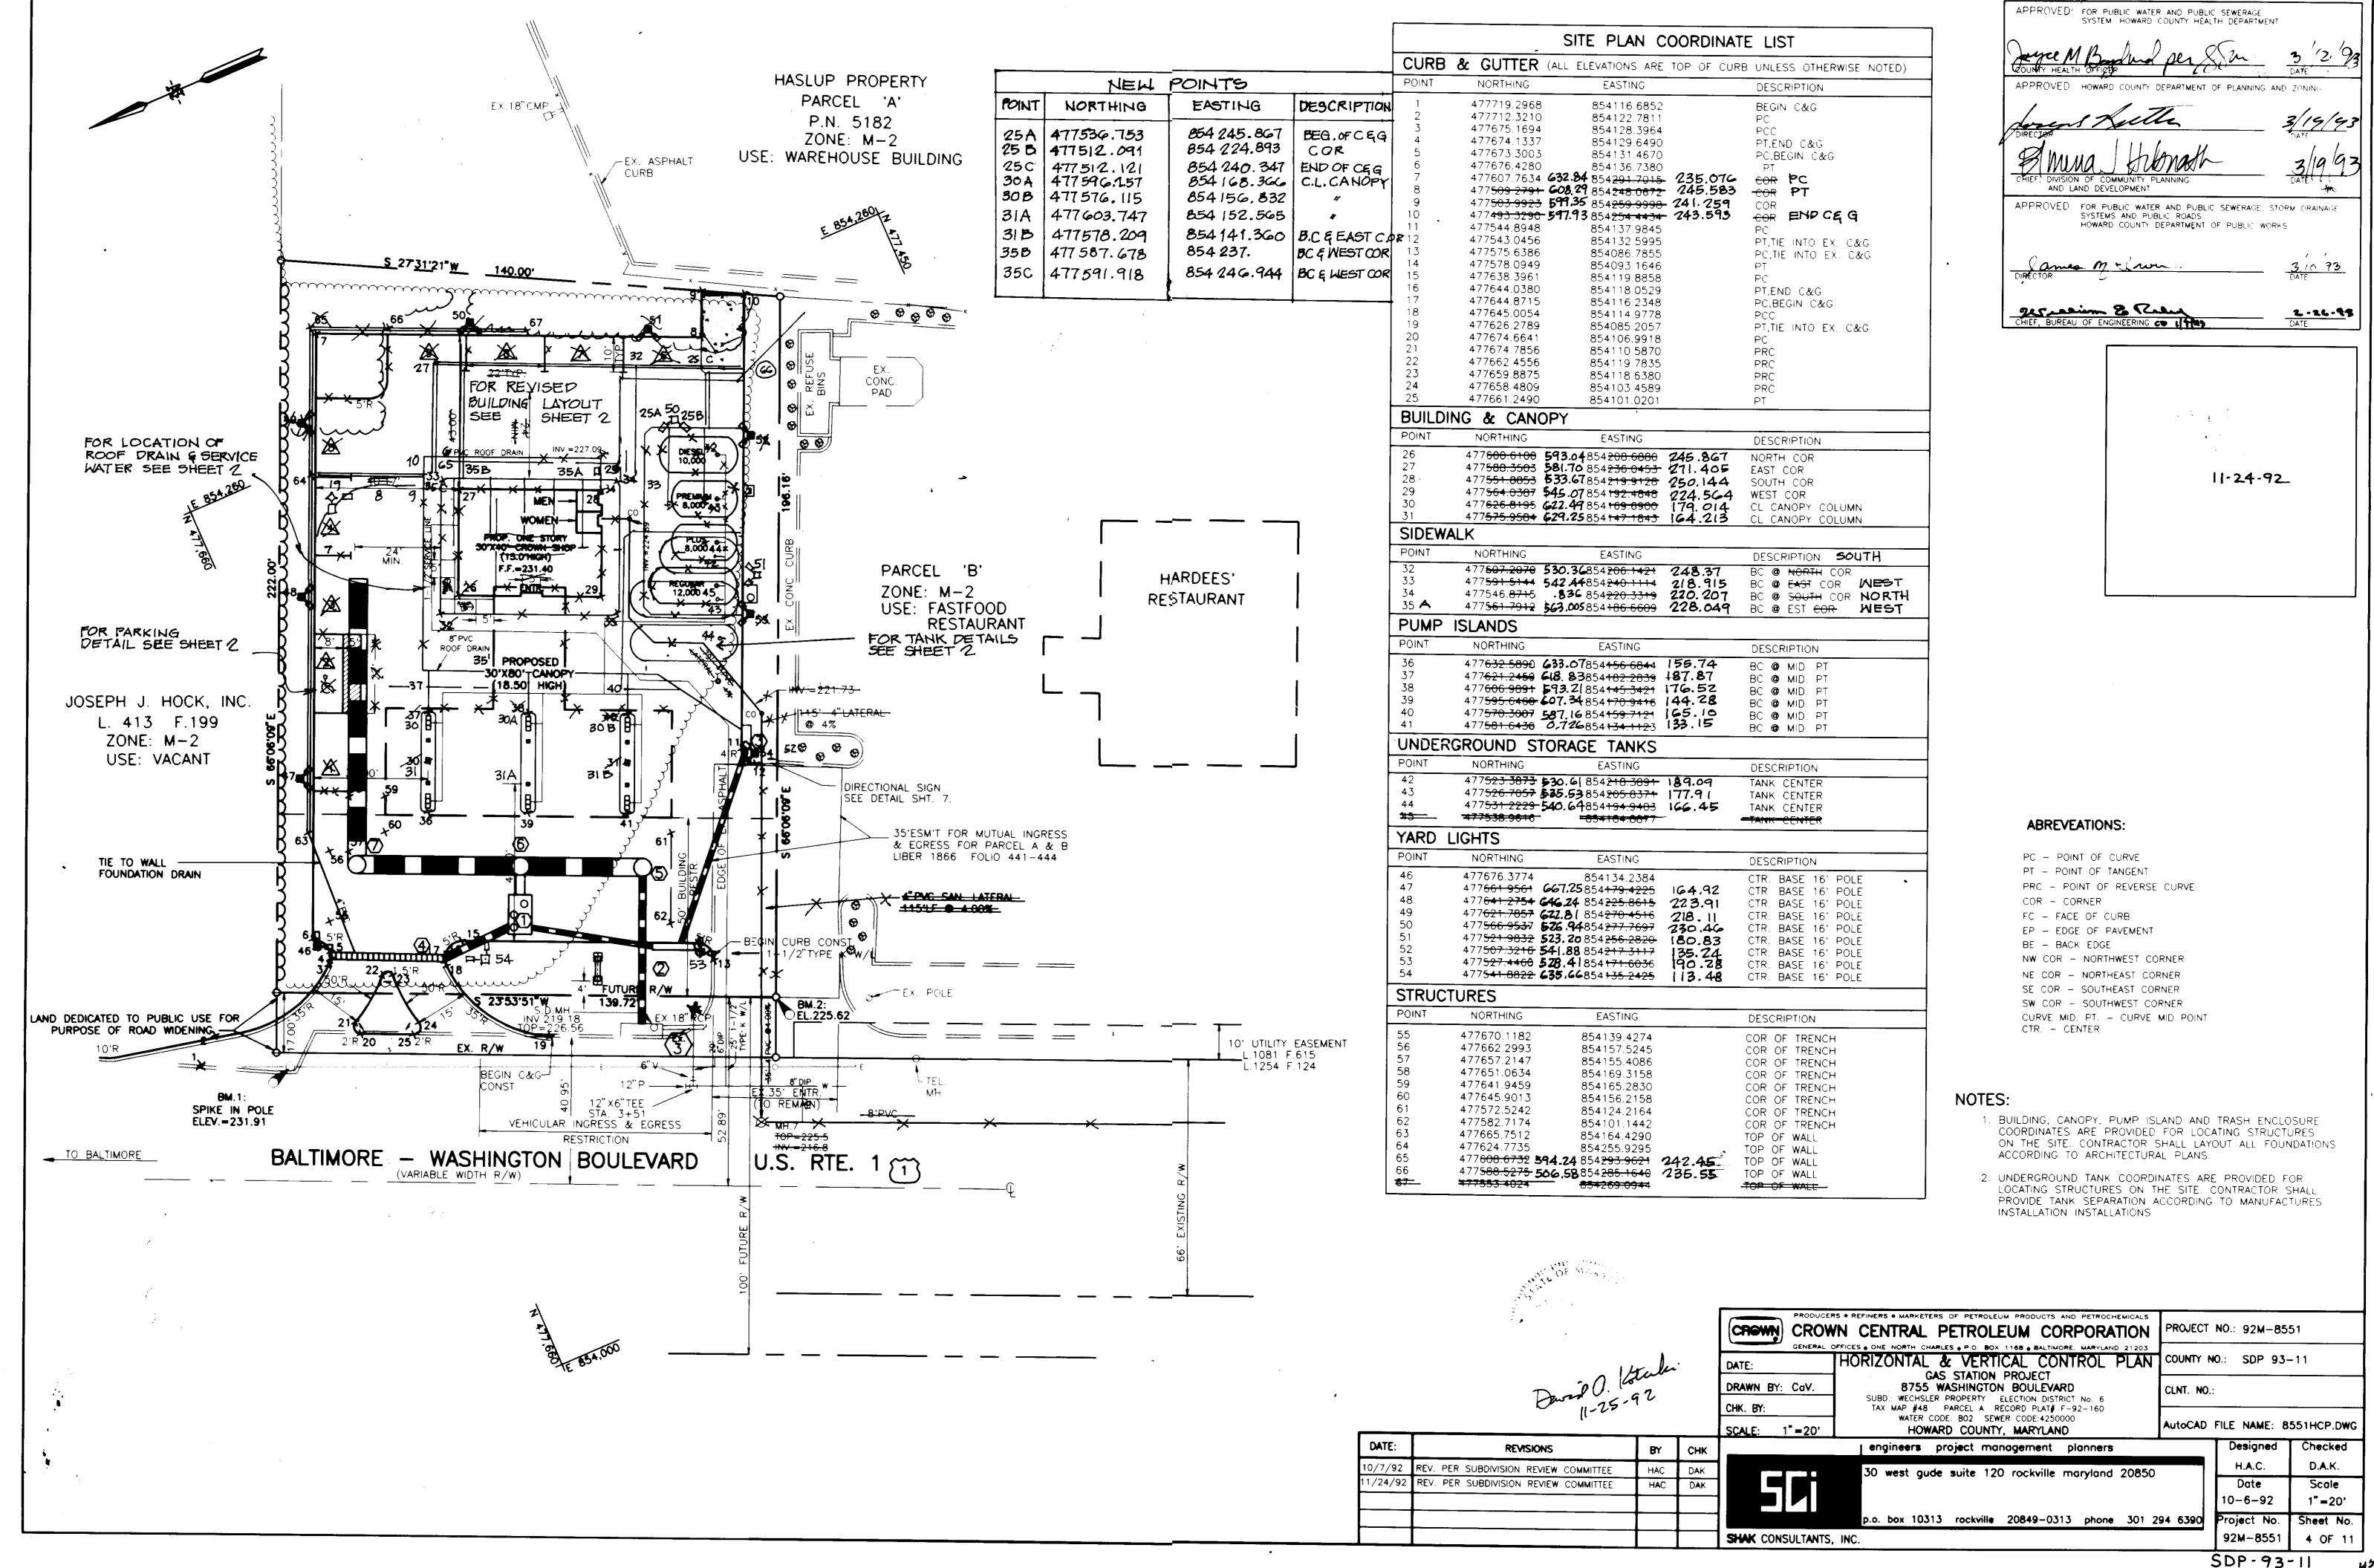

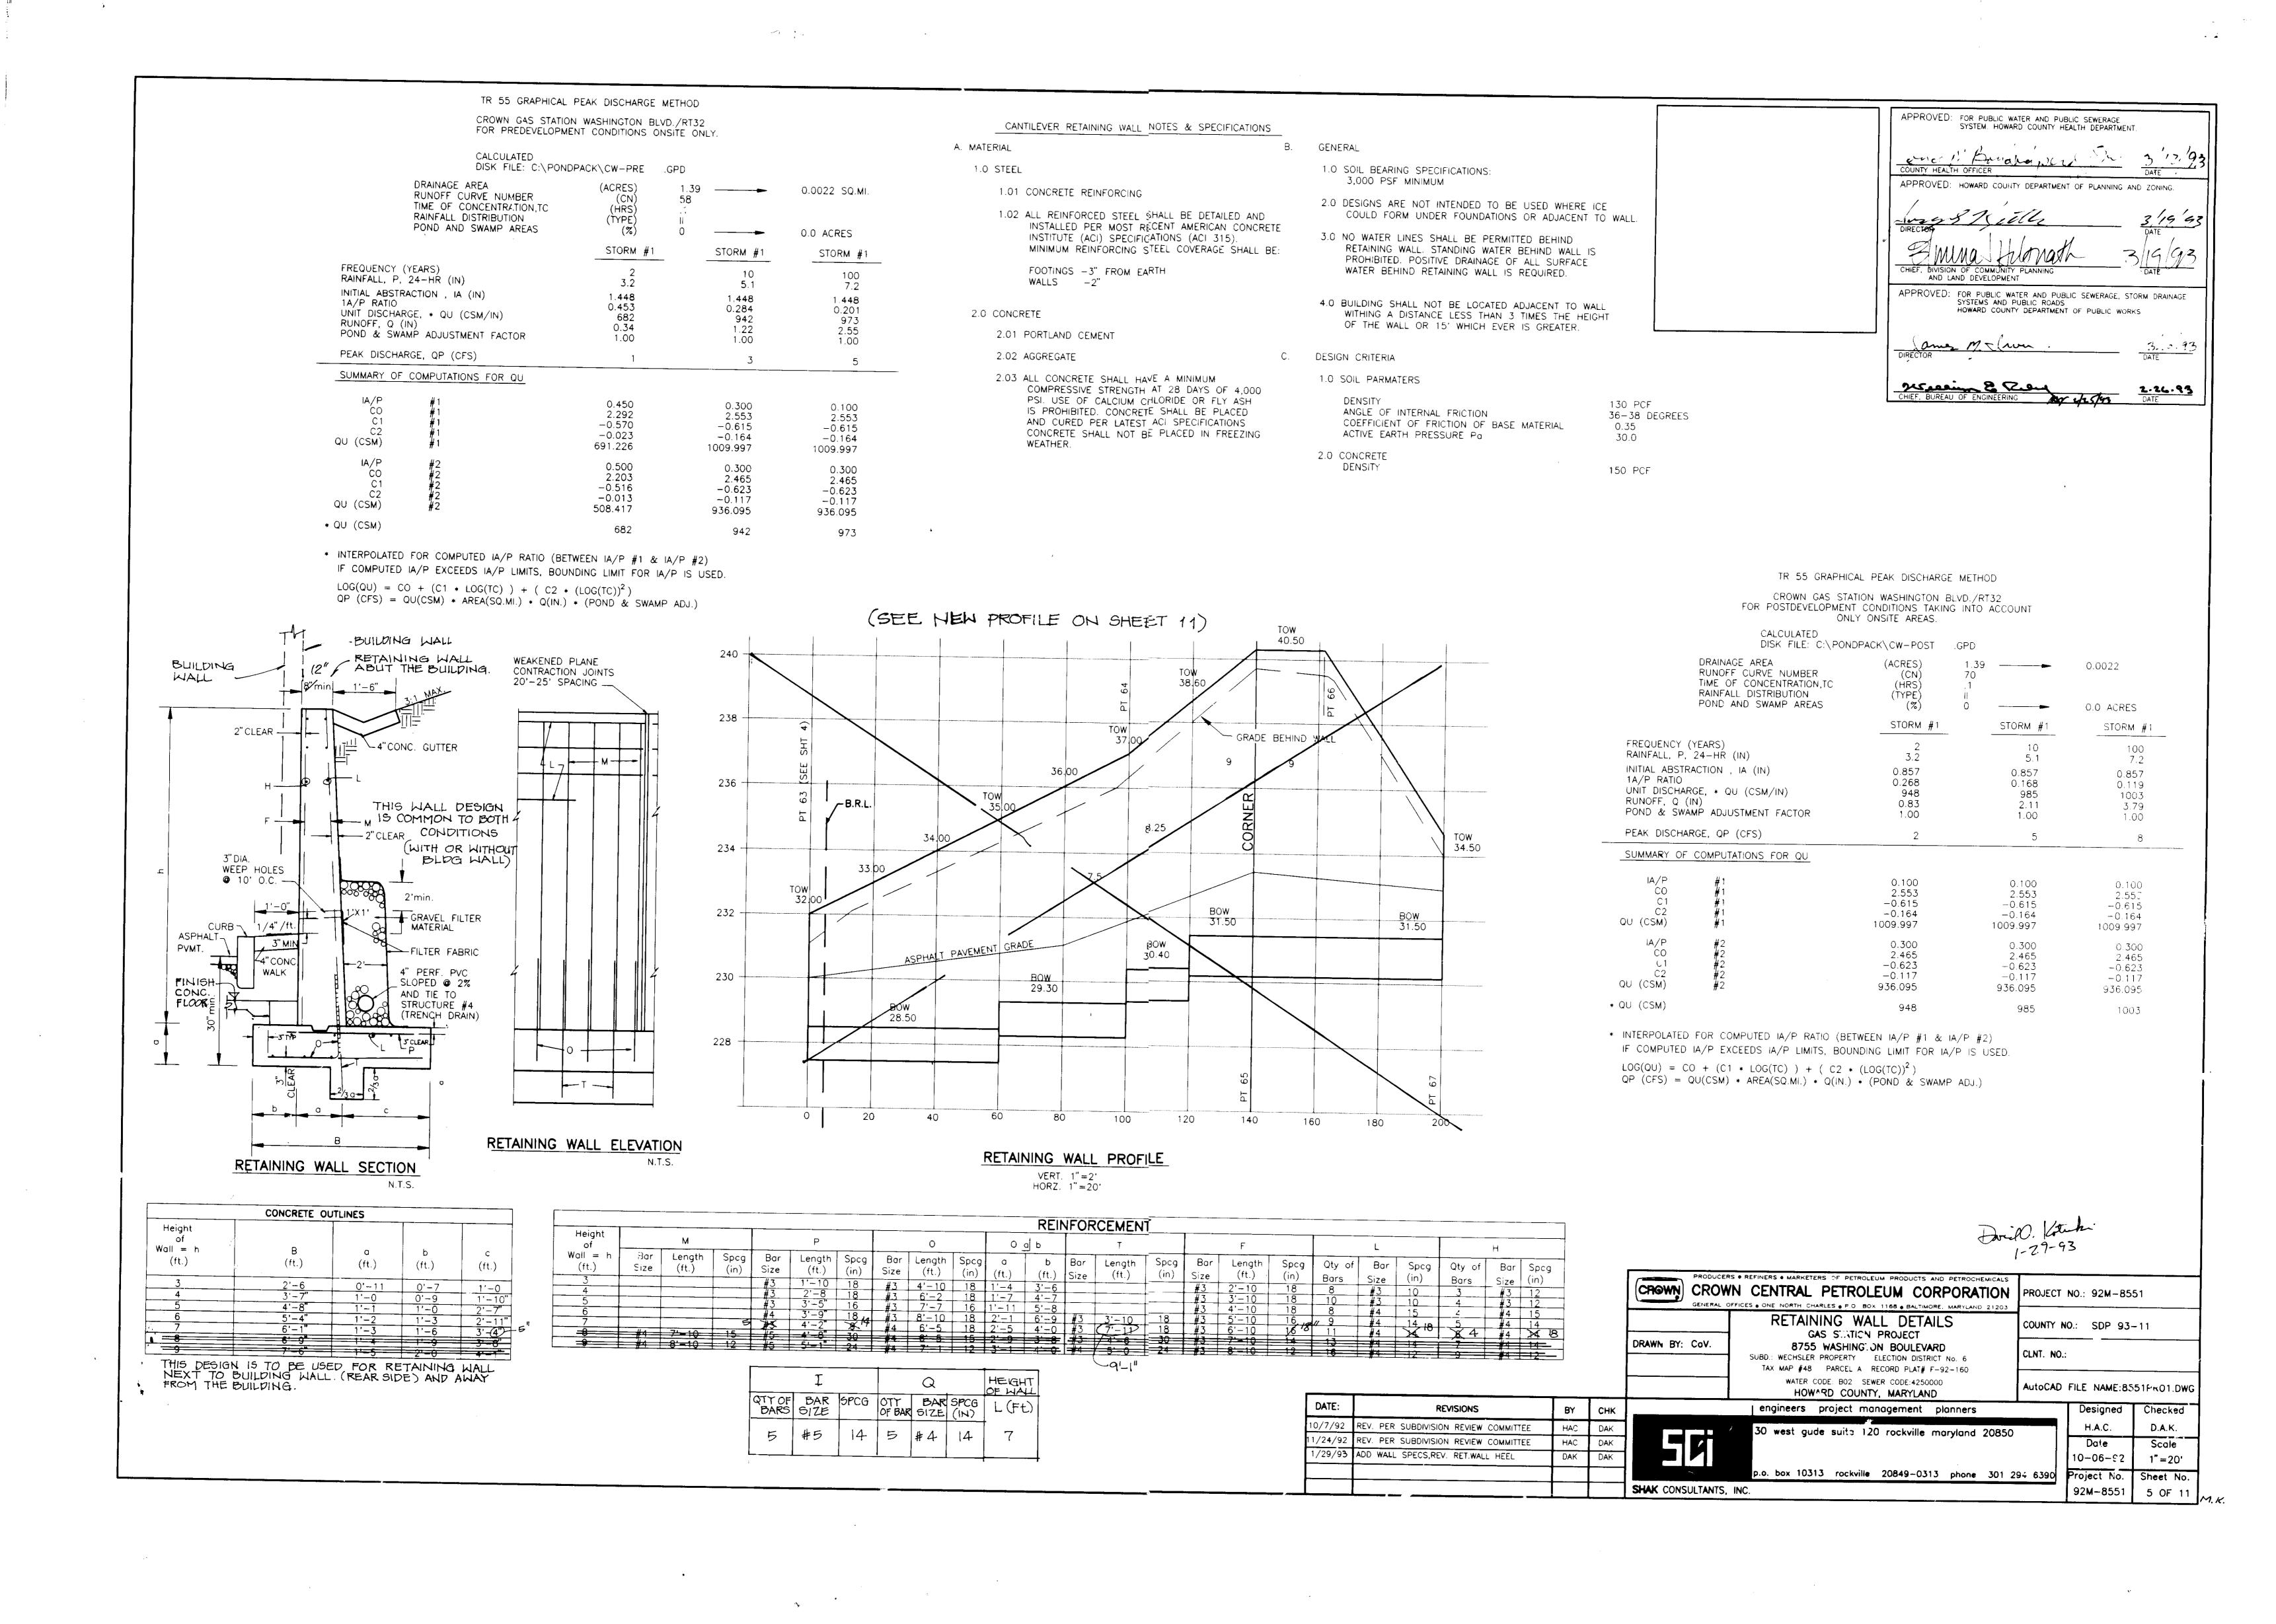


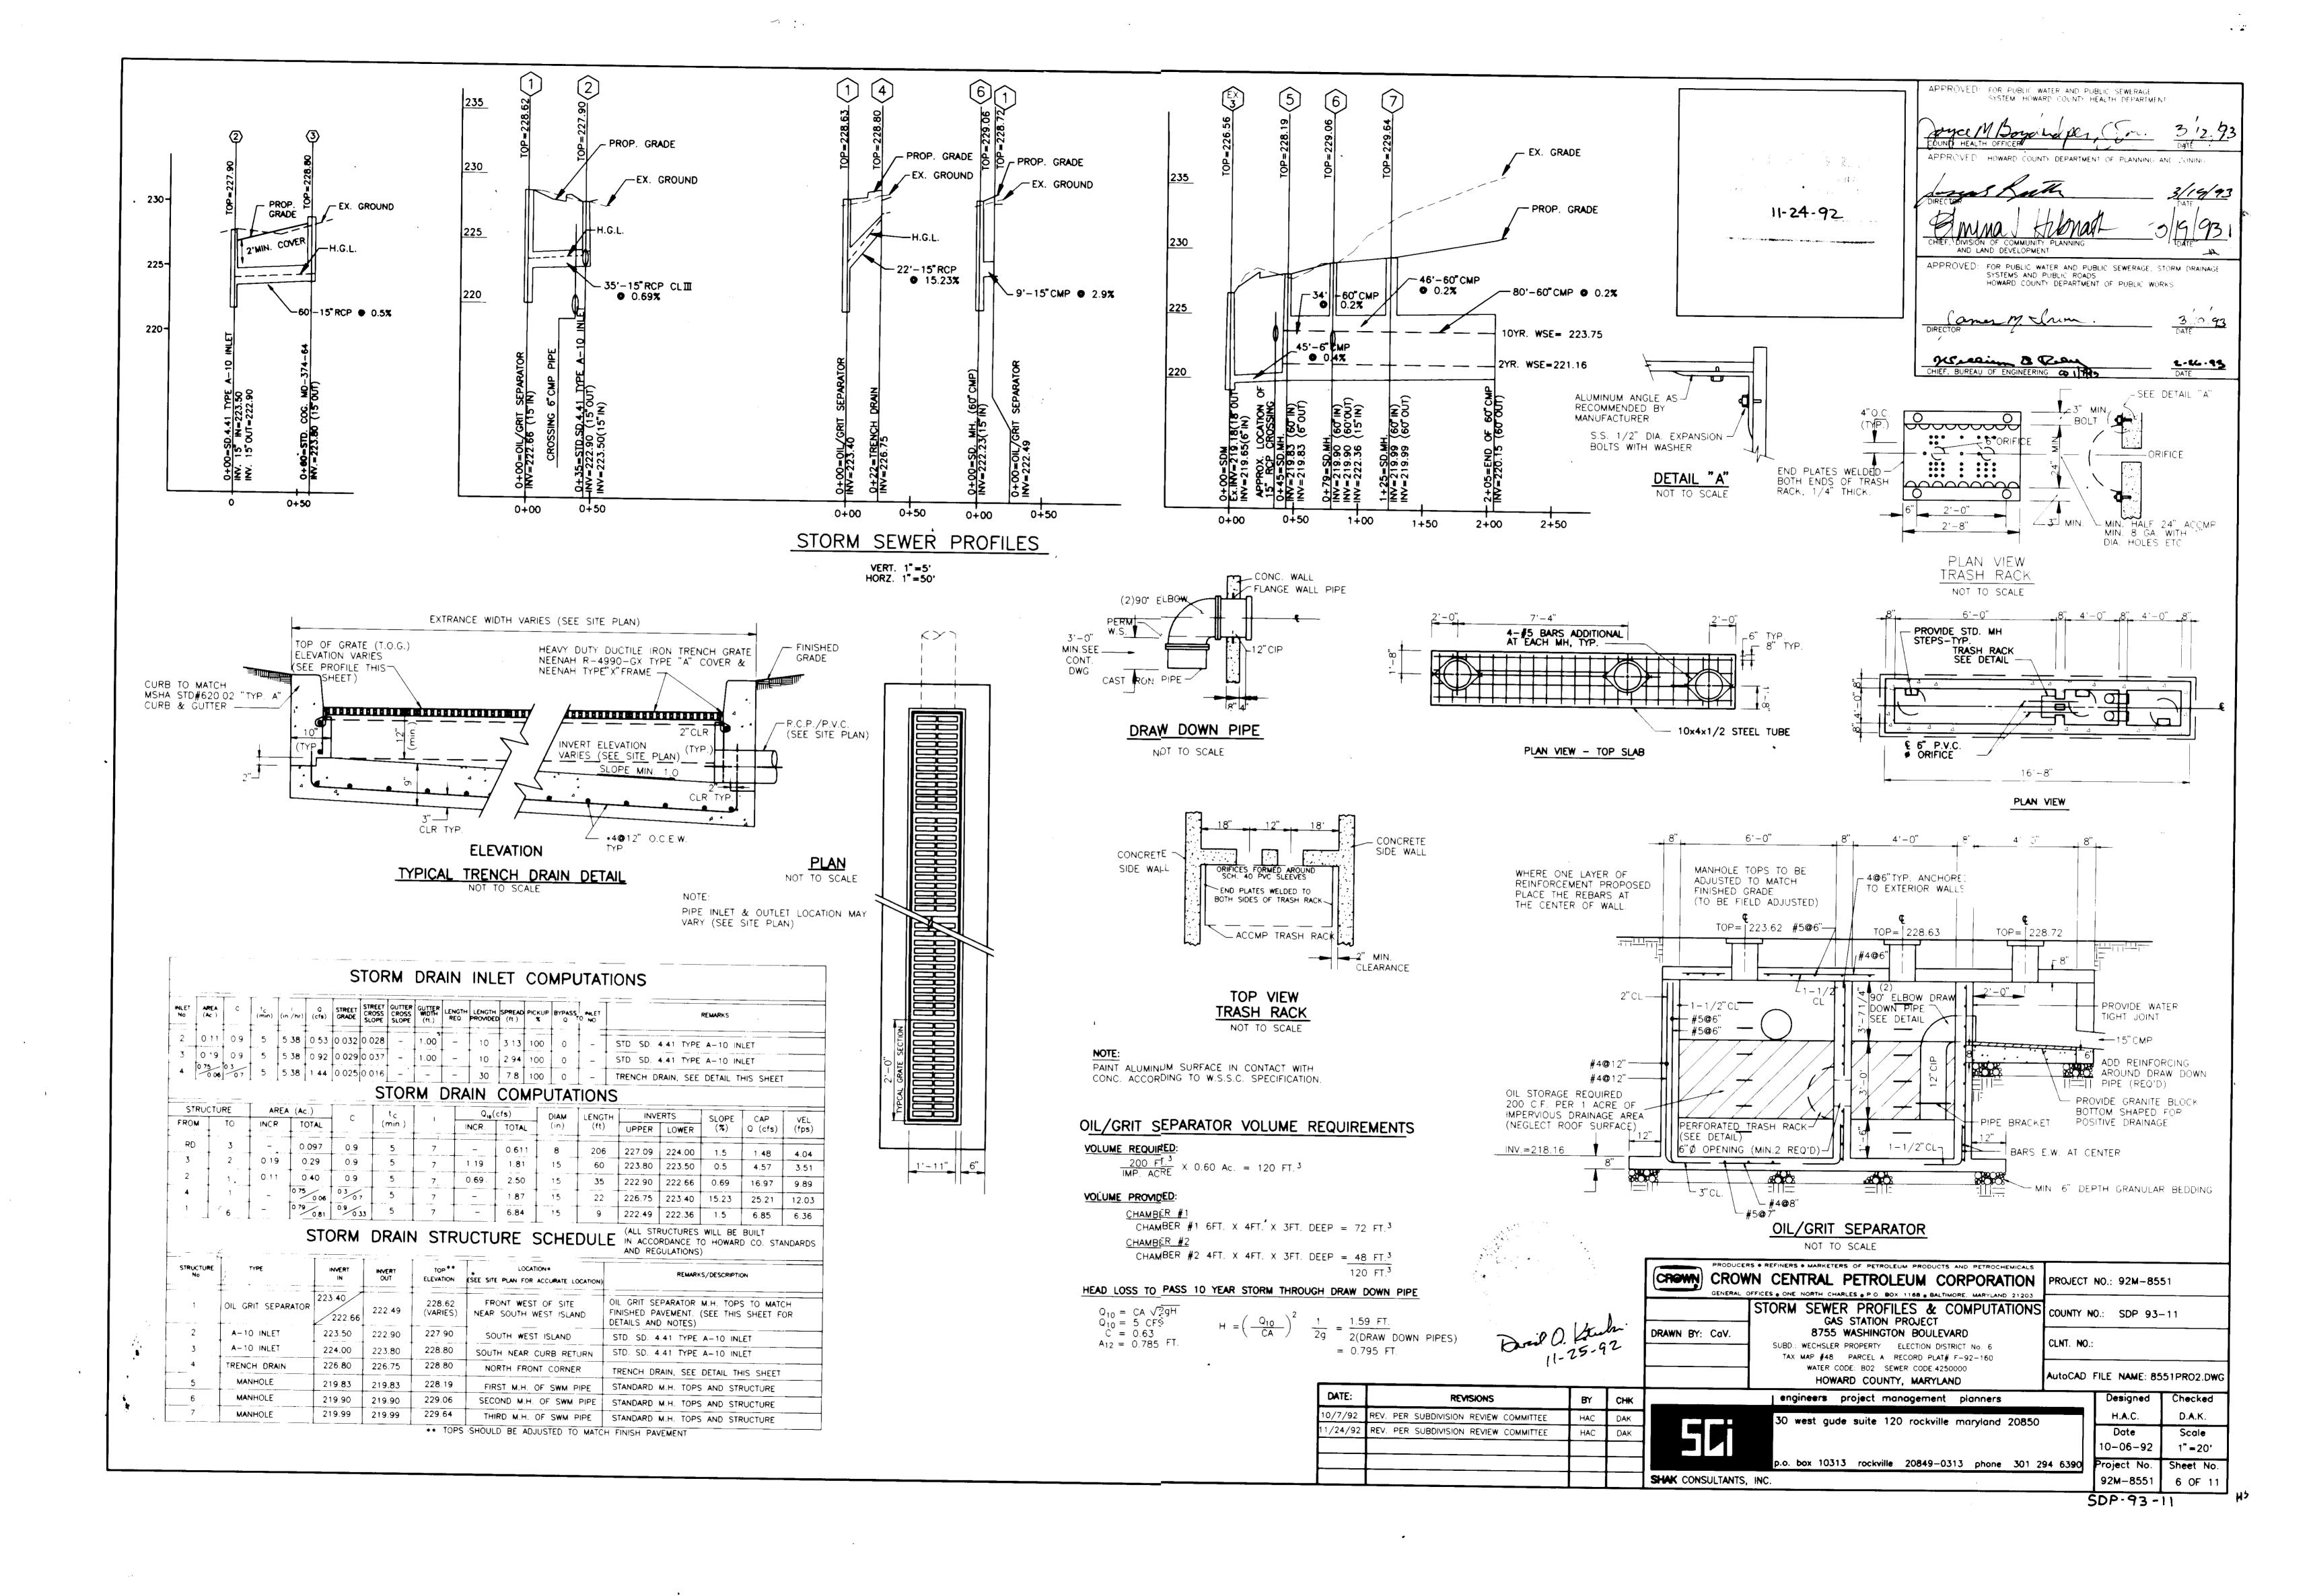

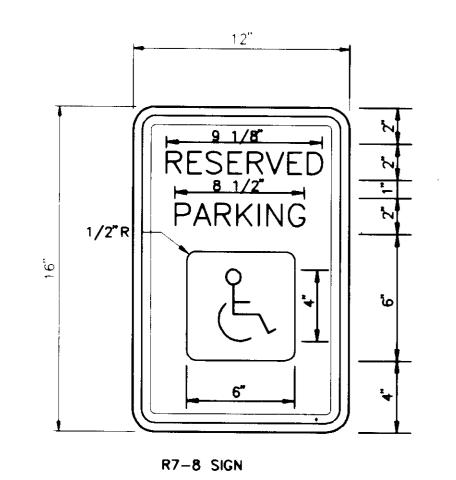

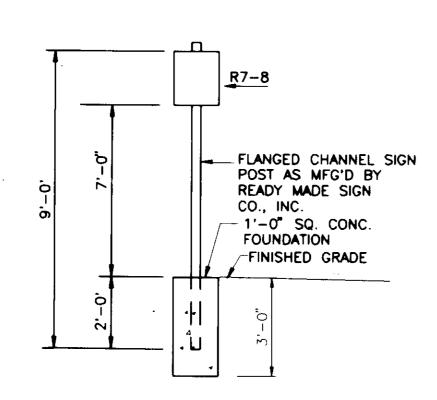


¬ :...

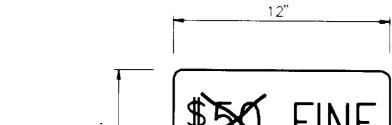


- 1.) A \$50.00 FINE SIGN, (ALUMINUM BLANK 6"X12"X0.080in. THICK) WITH 2 SINGLE POST MOUNTING HOLES. THE FINE SIGN SHALL BE MOUNTED UNDERNEATH THE BELOW R7-8 RESERVED PARKING SIGN.
- 2.) REFER TO THE STANDARD HOWARD CO. HANDICAPPED PARKING SIGN FOR MORE SPECIFICATIONS.

HANDICAPPED PARKING SIGN DETAIL NOT TO SCALE

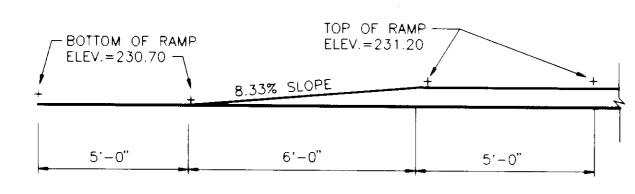


NOTE: THE HADICAPPED RAMP DETAIL INDICATES BOTH THE NORTH AND WEST SIDE ELEVATIONS OF CROWN SHOP.

HANDICAPPED RAMP NOT TO SCALE

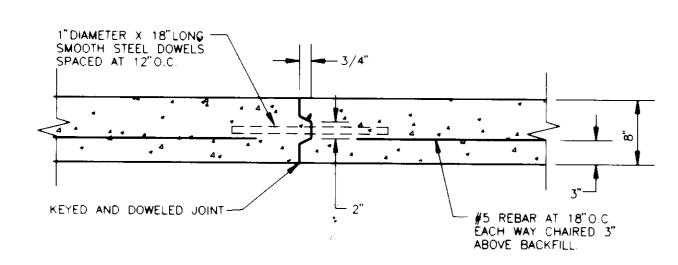

CONSTRUCTION JOINT

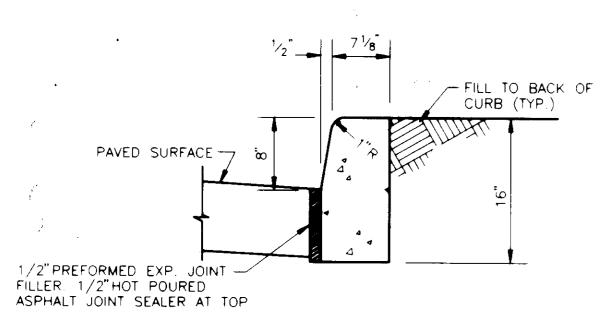


VERTICAL CURB DETAIL


TO BE USED AROUND CROWN BUILDING AND PUMP ISLANDS. FOR CURB AROUND PARKING AREA USE HOWARD CO. R.-3.03. FOR CURB AND GUTTER SECTIONS USE HOWARD COUNTY R-3.01.

FENCING NOTES:

FENCING CONTRACTOR SHALL NOT INSTALL ANY TYPE OF COMPANY LOGO OR SIMILAR IDENTIFICATION SIGN ON COMPLETED FENCE INSTALLATION.
 ALL GRADE MARKINGS/LUMBER STAMPS ETC. TO BE FACED TOWARDS CENTER LINE OF FENCE TO MINIMIZE VISIBILITY.

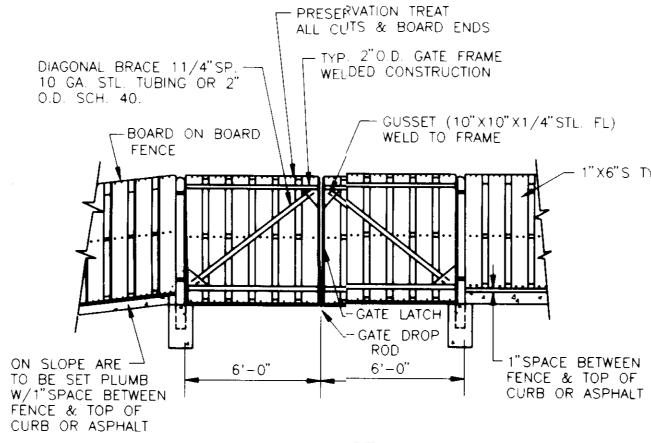


6 FOOT HIGH ELEVATION - DUMPSTER ENCLOSURE

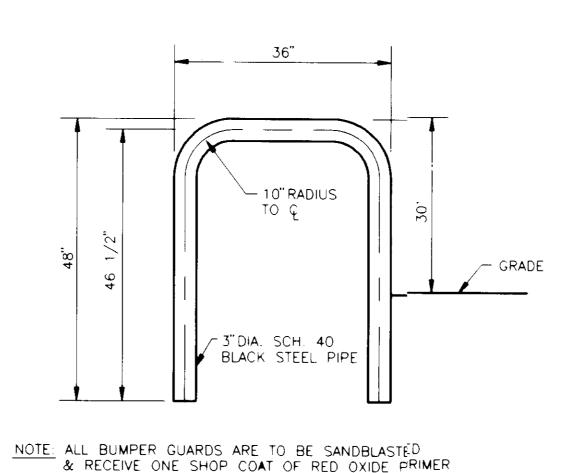

BUMPER GUARD DETAIL


PRIOR TO SHIPMENT.

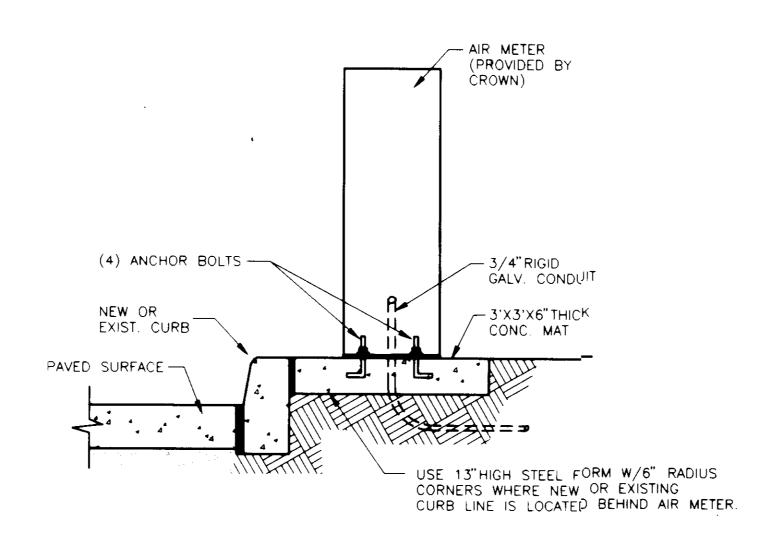

AIR METER DETAIL

NOTE:

THIS PLAN DOES NOT APPROVE ANY SIGN LOCATION, SIZE OR TYPE. CONTACT DILP FOR SIGN CODE REQUIREMENTS.

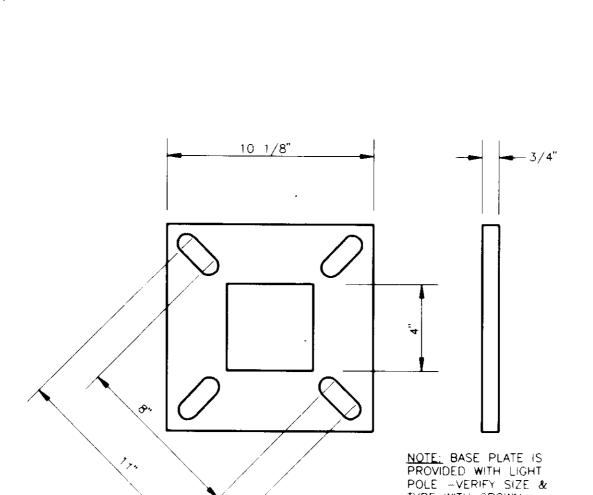

TYPE WITH CROWN.

AREA LIGHT BASE

PLATE DETAIL

__ 1 1/2" BITUMINOUS SURFACE COURSE, M.S.H.A. SF 2 1/2" BITUMINOUS BASE COURSE, M.S.H.A. BI COMPACTED SUBGRADE L 8" AGGREGATE BASE COURSE,

AND LAND DEVELOPMENT

11-24-92

APPROVED: FOR PUBLIC WATER AND PUBLIC SEWERAGE SYSTEM HOWARD COUNTY HEALTH DEPARTMENT

APPROVED: HOWARD COUNTY DEPARTMENT OF PLANNING AND ZONING


APPROVED: FOR PUBLIC WATER AND PUBLIC SEWERAGE, STORM DRAINAGE SYSTEMS AND PUBLIC ROADS HOWARD COUNTY DEPARTMENT OF PUBLIC WORKS

3 10 .73 DATE

2-26-95 DATE

NOTE: ASPHALT PAVEMENT DESIGN IS BASED ON AN ASSUMED C.B.R. VALUE OF 10

PAVING DETAIL BASED ON HOWARD CO. STANDARD P-2 (R-2.01,VOL. IV)NOT TO SCALE

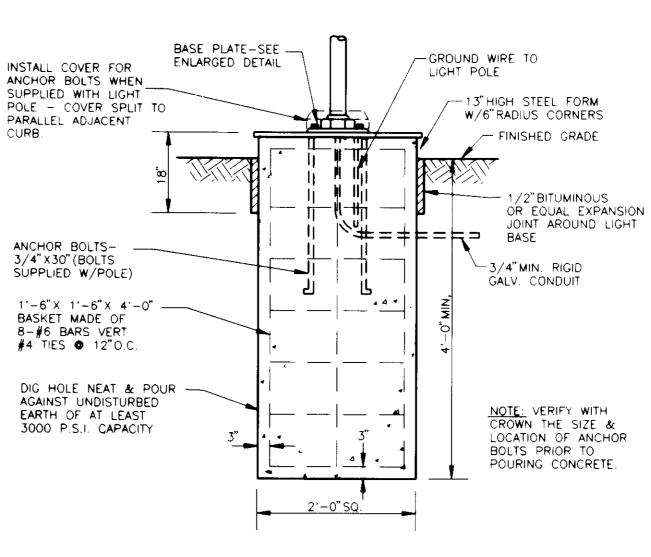



CHK

BY

HAC


HAC

REVISIONS

0/7/92 REV. PER SUBDIVISION REVIEW COMMITTEE

1/24/92 REV. PER SUBDIVISION REVIEW COMMITTEE

DATE:

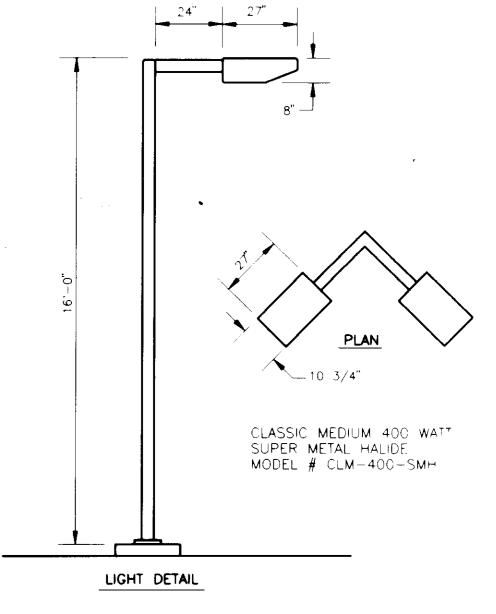

AREA LIGHT ELEVATION & PLAN

CROWN CENTRAL PETROLEUM CORPORATION GENERAL OFFICES . ONE NORTH CHARLES . P.O. BOX 1168 . BALTIMORE, MARYLAND 21203 SITE DETAILS GAS STATION PROJECT DRAWN BY: CaV. 8755 WASHINGTON BOULEVARD SUBD. WECHSLER PROPERTY ELECTION DISTRICT No. 6 TAX MAP #48 PARCEL A RECORD PLAT# F-92-160 WATER CODE: B02 SEWER CODE:4250000

HOWARD COUNTY, MARYLAND l engineers project management planners 30 west gude suite 120 rockville maryland 20850 p.o. box 10313 rockville 20849-0313 phone 301 294 6390 SHAK CONSULTANTS, INC.

PRODUCERS . REFINERS . MARKETERS OF PETROLEUM PRODUCTS AND PETROCHEMICALS

AutoCAD FILE NAME: 8551SD.DWG Checked Designed H.A.C. D.A.K. Date Scale 10-06-92 1"=20" Project No. Sheet No 92M-8551 7 OF 1


N.T.S.


PROJECT NO.: 92M-8551


COUNTY NO.: SDP 93-11


CLNT. NO.:

5DP-93-11

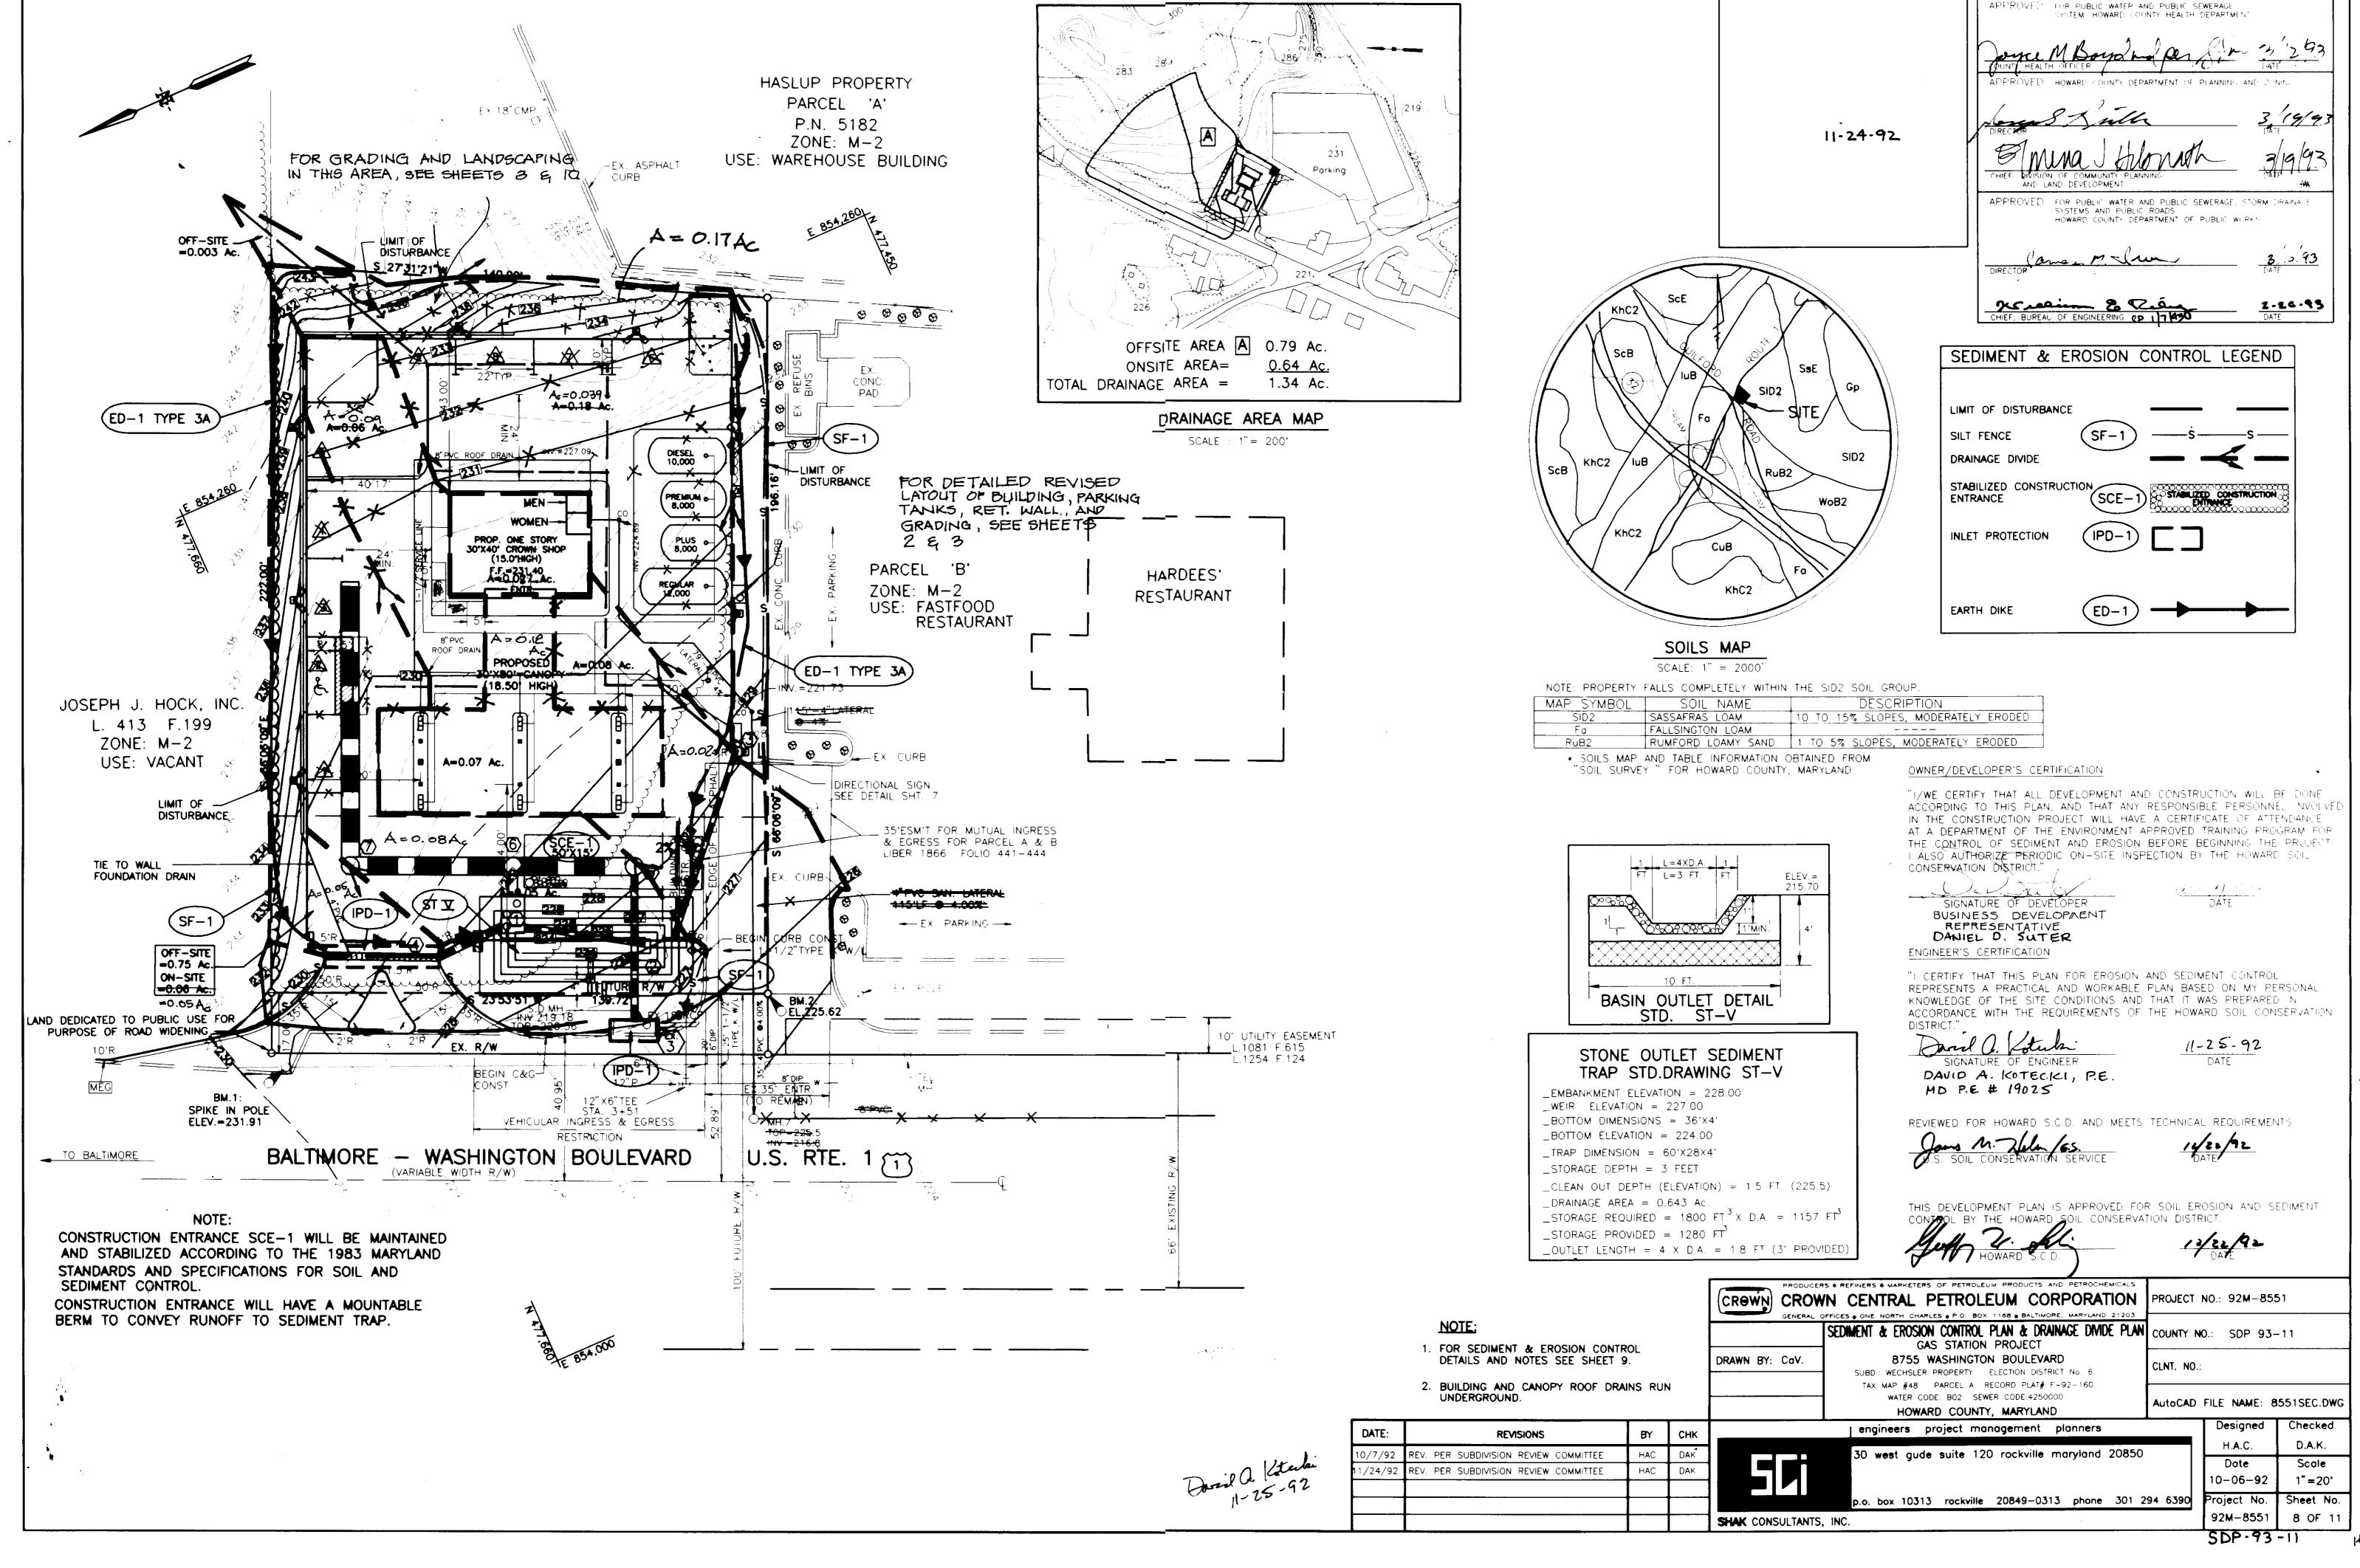

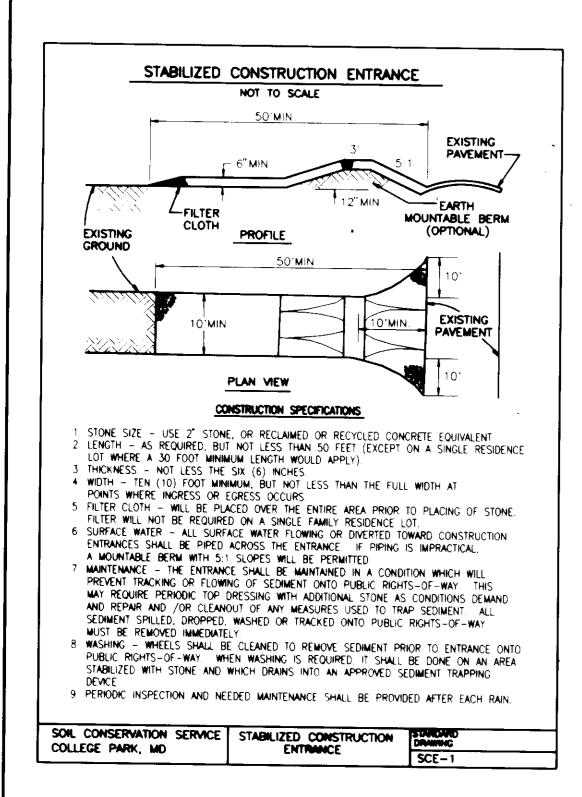

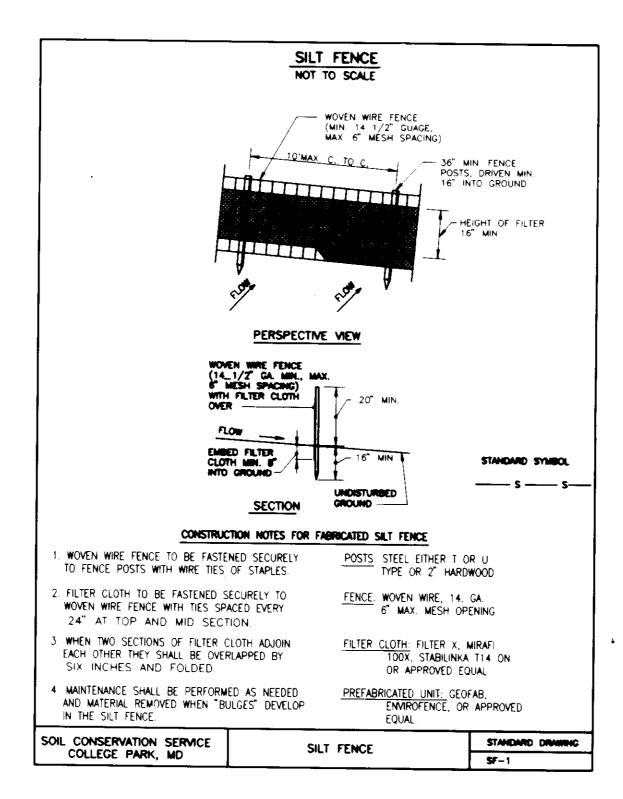

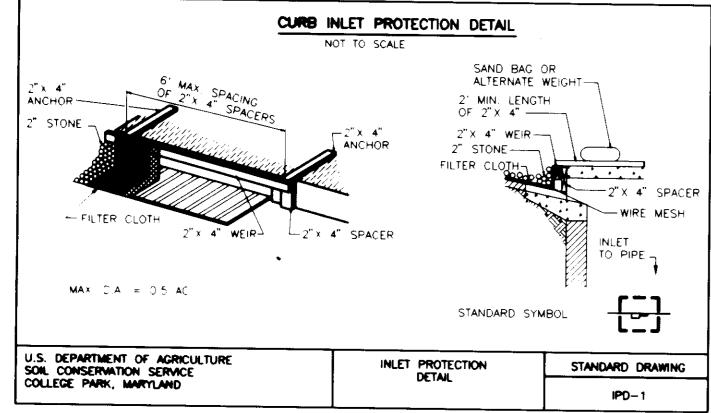

HOWARD SOIL CONSERVATION DISTRICT PERMANENT SEEDING NOTES

APPLY TO GRADED OF CLEARED AREAS NOT SUBJECT TO IMMEDIATE FURTHER DISTURBANCE WHERE A PERMANENT LONG-LIVED VEGETATIVE COVER IS NEEDED.

SEEDBED PREPARATION LOOSEN UPPER THREE INCHES OF SOIL BY RAKING, DISKING OR OTHER ACCEPTABLE MEANS BEFORE SEEDING, IF NOT PREVIOUSLY LOOSENED.

SOIL AMENDMENTS IN LIEU OF SOIL TEST RECOMMENDATIONS, USE ONE OF THE FOLLOWING SCHEDULES


- PREFERRED -- APPLY 2 TONS PER ACRES DOLOMITIC LIMESTONE (92 LBS/1000 SQ FT) AND 600 LBS PER ACRE 10-10-10 FERTILIZER (14 LBS/1000 SQ FT) BEFORE SEEDING. HARROW OR DISK INTO UPPER THREE INCHES OF SOIL. AT TIME OF SEEDING, APPLY 400 LBS PER ACRE 30-0-0 UREAFORM FERTILIZER (9 LBS/1000 SQ. FT.)
- 2 <u>ACCEPTABLE</u> -- APPLY 2 TONS PER ACRE DOLOMITIC LIMESTONE (92 LBS/1000 SQ FT.) AND 1000 LBS PER ACRE 10-10-10 FERTILIZER (23 LBS/1000 SQ. FT.) BEFORE SEEDING. HARROW OR DISK INTO UPPER THREE INCHES OF SOIL.

SEEDING -- FOR THE PERIODS MARCH 1 THRU APRIL 30, AND AUGUST 1 THRU OCTOBER 15, SEED WITH 60 LBS PER ACRE (1.4 LBS/1000 SQ. FT.) OF KENTUCKY 31 TALL FESCUE FOR THE PERIOD MAY 1 THRU JULY 31. SEED WITH 60 LBS KENTUCKY 31 TALL FESCUE PER ACRE AND 2 LBS PER ACRE (05 LBS/1000 SQ FT.) OF WEEPING LOVEGRASS. DURING THE PERIOD OF OCTOBER 1/6 THRU FEBRUARY 28, PROTECT SITE BY: OPTION 1 -2 TONS PER ACRE OF WELL ANCHORED STRAW MULCH AND SEED AS SOON AS POSSIBLE IN THE SPRING. OPTION 2 - USE SOD. OPTION 3 - SEED WITH 60/LBS ACRE KENTUCKY 31 TALL FESCUE AND MULCH WITH 2 TONS/ACRE WELL ANCHORED STRAW.

MULCHING -- APPLY 1-1/2 TO 2 TONS PER ACRE (70 TO 90 LBS/1000 SQ. FT.) OF UNROTTED SMALL GRAIN STRAW IMMEDIATELY AFTER SEEDING.

ANCHOR MULCH IMMEDIATELY AFTER APPLICATION USING MULCH ANCHORING TOOL OR 218 GALLONS PER ACRE (5 GAL/1000 SQ. FT.) OF EMULSIFIED ASPHALT ON FLAT AREAS. ON SLOPES 8 FEET OR HIGHER, USE 348 GALLONS PER ACRE (8 GAL/1000 SQ. FT.) FOR ANCHORING.

MAINTENANCE -- INSPECT ALL SEEDING AREAS AND MAKE NEEDED REPAIRS, REPLACEMENTS AND RESEEDINGS.

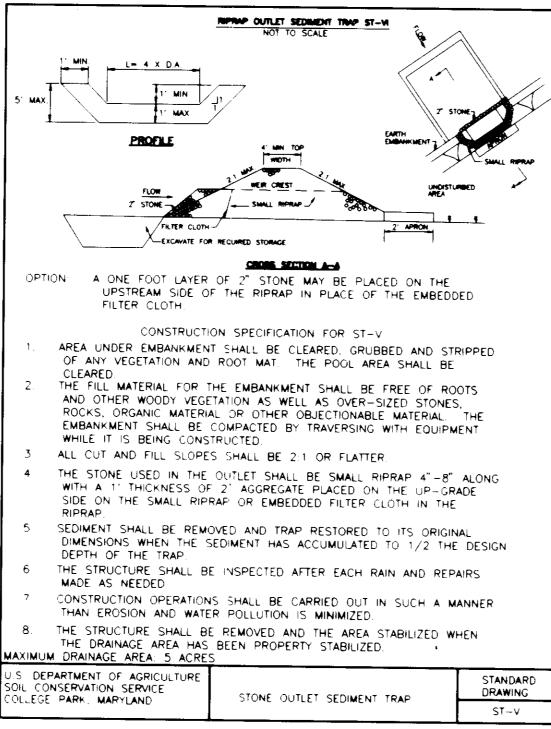

TEMPORARY SEEDING NOTES

APPLY TO GRADED OR CLEARED AREAS LIKELY TO BE REDISTURBED WHERE A SHORT-TERM VEGETATIVE COVER IS NEEDED.

SEEDBED PREPARATION -- LOOSEN UPPER THREE INCHES OF SOIL BY RAKING, DISKING OR OTHER ACCEPTABLE MEANS BEFORE SEEDING, IF NOT PREVIOUSLY LOOSENED.

SOIL AMENDMENTS -- APPLY 600 LBS PER ACRE OF 10-10-10 FERTILIZER (14 LBS/1000 SQ. FT)

SEEDING —— FOR PERIODS MARCH 1 THRU APRIL 30 AND FROM AUGUST 15 THRU OCTOBER 15, SEED WITH 2-1/2 BUSHELS PER ACRE OF ANNUAL RYE (3.2 LBS/100 SQ. FT.). FOR THE PERIOD MAY 1 THRU AUGUST 14, SEED WITH 3 LBS PER ACRE OF WEEPING LOVEGRASS (.07 LBS/1000 SQ. FT.). FOR THE PERIOD NOVEMBER 16 THRU FEBRUARY 28, PROTECT SITE BY APPLYING 2 TONS PER ACRE OF WELL ANCHORED STRAW MULCH AND SEED AS SOON AS POSSIBLE IN THE SPRING, OR USE SOD.

MULCHING -- APPLY 1-1/2 TO 2 TONS PER ACRE (70 TO 90 LBS/1000 SQ. FT.) OF UNROTTED WEED FREE SMALL GRAIN STRAW IMMEDIATELY AFTER SEEDING. ANCHOR MULCH IMMEDIATELY AFTER APPLICATION USING MULCH ANCHORING TOOL OR 218 GAL PER ACRE (5 GAL/1000 SQ. FT.) OF EMULSIFIED ASPHALT ON FLAT AREAS. ON SLOPES 8 FT. OR HIGHER, USE 348 GAL PER ACRE (8 GAS/1000 SQ. FT.) FOR ANCHORING.

REFER TO THE 1983 MARYLAND STANDARDS AND SPECIFICATIONS FOR SOIL EROSION AND SEDIMENT CONTROL FOR ADDITIONAL RATES AND METHODS NOT COVERED.

CONSTRUCTION SEQUENCE / EROSION AND SEDIMENT CONTROL NARRATIVE

THIS PROJECT IS TO BE CONSTRUCTED IN SUCH A MANNER AS TO MINIMIZE THE EFFECTS OF SECTATION AND ERGSION THE SILTATION—EROSION CONTROL PLAN IS TO BE ADHERED TO AND ALL NECESSARY MEASURES WILL BE TAKEN TO INSURE THAT UNDISTURBED AREAS NOT CONTAMINATED BY RUNOFF FROM THE CONSTRUCTION AREA.

PROJECT DESCRIPTION:

THIS PROJECT CONSISTS OF THE CONSTRUCTION OF A GASOLINE SERVING FACILITY ON 0.6434 ACRES. THE SITE IS LOCATED IN HOWARD COUNTY, MARYLAND, APPROXIMATELY 200 FEET NORTH OF GUILFORD ROAD.

EXISTING SITE CONDITIONS:

THE PROPOSED SITE IS AN AREA OF MODERATELY STEEP TERRAIN WITH UNDISTURBED LAND BORDERING THE SITE TO THE NORTH AND AN EXISTING WAREHOUSE TO THE EAST. TO THE SOUTH, THE SITE BORDERS AN EXISITNG HARDEE'S RESTAURANT. APPROXIMATELY 85 PERCENT OF THE SITE IS COVERED WITH TREES. THE REMAINING 15 PERCENT CONSISTS OF SPARSE NATURAL GROWTH OF WEEDS AND GRASSES.

SOILS DATA:

SEE SOILS MAP AND DESCRIPTION ON SHEET 8.

EROSION AND SEPIMENT CONTROL MEASURES:

CUT AND FILL SLOPES SHALL BE GRADED AT A MAXIMUM SLOPE OF 2:1.
EMBANKMENT OR EXCAVATED SLOPES DENUDED FOR A PERIOD GREATER THAN 30
DAYS SHALL BE TEMPORARILY SEEDED AND/OR MULCHED ACCORDING TO HOWARD
SOIL CONSERVATION DISTRICT SPECIFICATIONS (SEE NOTES THIS SHEET).
REVEGETATION SHALL BE ACCOMPLISHED AS SOON AS POSSIBLE.

SILTATION CONTROL PROGRAM:

CONTROL WILL BE EXERCISED THROUGH THE INSTALLATION OF DIVERSION DIKES SILT FENCES. FOR PERIMETER CONTROL AND AT THE BASE OF SLOPES AND INLET PROTECTION AT STORM SEWER INLETS. ALL VEGETATIVE AND STRUCTURAL EROSION AND SEDIMENT CONTROL PRACTICES WILL BE CONSTRUCTED AND MAINTAINED ACCORDING TO THE LATEST EDITION OF THE MARYLAND STANDARDS AND SPECIFICATIONS FOR SOIL EROSION AND SEDIMENT CONTROL


CONSTRUCTION SEQUENCE:

ESTIMATED DURATION OF ACTIVITIES IS 80 DAYS. THIS SEQUENCE WILL BE SUBJECT TO CHANGE BY THE HOWARD COUNTY SITE INSPECTOR AND CROWN CORPORATION

- 1. GRADING PERMIT MUST BE OBTAINED FROM THE DEPARTMENT OF INSPECTION LICENSE, AND PERMIT PRIOR TO STARTING THE
- 2. INSTALL TEMPORARY CONSTRUCTION ENTRANCE.
- 3. CLEAR AND GRUB TO INSTALL TEMPORARY DIVERSION DIKE, SILT FENCE AND SILT TRAP ONLY.
- 4. THE PLACEMENT OF SILT FENCES SHALL BE COMPLETED PRIOR TO THE REMAINDER OF THE SITE BEING CLEARED AND ROUGH GRADED.
- 5. EXCAVATE AREA FOR SWM PIPES, STORM SEWER PIPES, OIL AND GRIT SEPARATOR STRUCTURE AND TRENCH DRAIN.
- 6. INSTALL, SWM PIPES, STORM SEWER PIPES AND STRUCTURES,

SANITARY SEWER LATERAL, WATER METER AND SERVICE.

- 7. CONSTRUCT NEW FOUNDATIONS (BUILDING, CANOPY AND RETAINING WALL), INSTALL UNDERGROUND STORAGE TANKS AND REMAINING UNDERGROUND UTILITIES. PROVIDE TEMPORARY SEEDING AS REQUIRED.
- 8. INSTALL CURB AND GUTTER, MAKE SMOOTH TRANSITION TO EXISTING CURB LINE, AND AVOID FALSE GUTTERS.
- 9. COMPLETE CONSTRUCTION OF RETAINING WALL.
- 10. BRING AREA AROUND RETAINING WALL UP TO FINAL GRADE AND STABILIZE WITH TEMPORARY SEEDING
- 11. THE BASE STONE FOR PAVEMENT SHOULD BE APPLIED WITHIN 5 DAYS OF REACHING FINAL GRADE FOR THE SUB-GRADE.
- 12. CONSTRUCT CONCRETE PAD AND PUMP ISLANDS.
- 13. ONCE CURB AND GUTTER AND UTILITIES ARE COMPLETED AND STORM SEWER IS FUNCTIONAL, INLET PROTECTION CAN BE INSTALLED.
- 14. INSTALL BASE PAVING.
- 15. INSTALL NEW BUILDING AND CANOPY.
- 16 INSTALL FINAL PAVING AND PERMANENTLY STABILIZE SITE WITH PLANTING AND SEEDING.
- 17. AFTER CONSTRUCTION OPERATIONS HAVE ENDED AND ALL DISTURBED AREAS HAVE BEEN STABILIZED WITH PERMANENT VEGETATION, AND AFTER PERMISSION IS GRANTED FROM THE COUNTY SEDIMENT CONTROL INSPECTOR MECHANICAL SEDIMENT CONTROLS SHALL BE REMOVED.

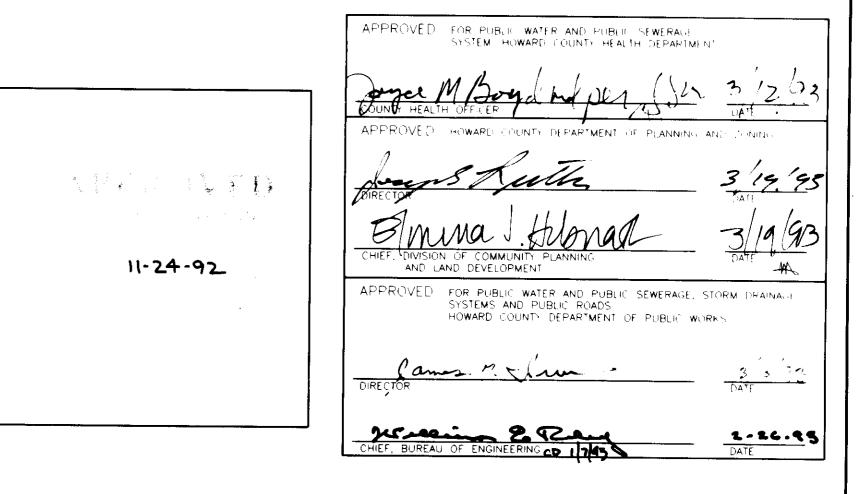

HOWARD SOIL CONSERVATION DISTRICT

STANDARD SEDIMENT CONTROL NOTES

- 1. A MINIMUM OF 48 HOURS NOTICE MUST BE GIVEN TO THE HOWARD COUNTY DEPARTMENT OF INSPECTIONS, LICENSES AND PERMITS, SEDIMENT CONTROL DIVISION PRIOR TO THE START OF ANY CONSTRUCTION, 880-3450.
- 2. ALL VEGETATIVE AND STRUCTURAL PRACTICES ARE TO BE INSTALLED ACCORDING TO THE PROVISIONS OF THIS PLAN AND ARE TO BE IN CONFORMANCE WITH THE MOST CURRENT "MARYLAND STANDARDS AND SPECIFICATIONS FOR SOIL EROSION AND SEDIMENT CONTROL", AND REVISIONS THERETO.
- 3. FOLLOWING INITIAL SOIL DISTURBANCE OR REDISTURBANCE, PERMANENT OR TEMPORARY STABILIZATION SHALL BE COMPLETED WITHIN: A) 7 CALENDAR DAYS FOR ALL PERIMETER SEDIMENT CONTROL STRUCTURES, DIKES, PERIMETER SLOPES AND ALL SLOPES GREATER THAN 3:1, B) 14 DAYS AS TO ALL OTHER DISTURBED OR GRADED AREAS ON THE PROJECT SITE.
- 4. ALL SEDIMENT TRAPS/BASINS SHOWN MUST BE FENCED AND WARNING SIGNS POSTED AROUND THEIR PERIMETER IN ACCORDANCE WITH VOL. 1. CHAPTER 12 OF THE HOWARD COUNTY DESIGN MANUAL, STORM DRAINAGE
- 5. ALL DISTURBED AREAS MUST BE STABILIZED WITHIN THE TIME PERIOD SPECIFIED ABOVE IN ACCORDANCE WITH THE 1983 MARYLAND STANDARDS AND SPECIFICATIONS FOR SOIL EROSION AND SEDIMENT CONTROL FOR PERMANENT SEEDING (SEC. 51), SOD (SEC 54), TEMPORARY SEEDING (SEC. 50) AND MULCHING (SEC. 52). TEMPORARY STABILIZATION WITH MULCH ALONE CAN ONLY BE DONE WHEN RECOMMENDED SEEDING DATES DO NOT ALLOW FOR PROPER GERMINATION AND ESTABLISHMENT OF GRASSES.
- 6. ALL SEDIMENT CONTROL STRUCTURES ARE TO REMAIN IN PLACE AND ARE TO BE MAINTAINED IN OPERATIVE CONDITION UNTIL PERMISSION FOR THEIR REMOVAL HAS BEEN OBTAINED FROM THE HOWARD COUNTY SEDIMENT CONTROL INSPECTOR.
- 7. SITE ANALYSIS
 - TOTAL AREA OF SITE

 AREA DISTURBED

 AREA TO BE ROOFED OR PAVED

 AREA TO BE VEGETATIVELY STABILIZED 0.09

 TOTAL CUT

 O.643

 O.643

TOTAL FILL

OFFSITE WASTE/BORROW AREA LOCATION TO BE PREAPPROVED BY THE COUNTISEDIMENT CONTROL INSPECTOR

- 8. ANY SEDIMENT CONTROL PRACTICE WHICH IS DISTURBED BY GRADING ACTIVITY FOR PLACEMENT OF UTILITIES MUST BE REPAIRED ON THE SAME DAY OF DISTURBANCE.
- 9. ADDITIONAL SEDIMENT CONTROL MUST BE PROVIDED, IF DEEMED NECESSARY BY THE HOWARD COUNTY SEDIMENT CONTROL INSPECTOR.
- 10. ON ALL SITES WITH DISTURBED AREAS IN EXCESS OF TWO ACRES, APPROVAL OF THE INSPECTION AGENCY SHALL BE REQUESTED UPON COMPLETION OF INSTALLATION OF PERIMETER EROSION AND SEDIMENT CONTROLS, BUT BEFORE PROCEEDING WITH ANY OTHER EARTH DISTURBANCE OR GRADING. OTHER BUILDING OR GRADING INSPECTION APPROVALS MAY NOT BE AUTHORIZED UNTIL THIS INITIAL APPROVAL BY THE INSPECTION AGENCY IS MADE.
- 11. TRENCHES FOR THE CONSTRUCTION OF UTILITIES IS LIMITED TO THREE PIPE LENGTHS OR THAT WHICH CAN BE BACK FILLED AND STABILIZED WITHIN ONE WORKING DAY, WHICHEVER IS SHORTER.

(CROWN) CRO	WN CENTRAL PETROLEUM CORPORATION OFFICES • ONE NORTH CHARLES • P.O. BOX 1168 • BALTIMORE, MARYLAND 21203	PROJECT NO.: 92M-8551
	SEDIMENT & EROSION CONTROL, DETAILS & NOTES GAS STATION PROJECT	COUNTY NO.: SDP 93-11
DRAWN BY: CaV.	8755 WASHINGTON BOULEVARD SUBD.: WECHSLER PROPERTY ELECTION DISTRICT No. 6	CLNT. NO.:
	TAX MAP #48 PARCEL A RECORD PLAT# F-92-160 WATER CODE: B02 SEWER CODE:4250000 HOWARD COUNTY, MARYLAND	AutoCAD FILE NAME: 8551SECD.DWG

DATE: REVISIONS BY CHK

10/7/92 REV. PER SUBDIVISION REVIEW COMMITTEE HAC DAK

11/24/92 REV. PER SUBDIVISION REVIEW COMMITTEE HAC DAK

SHAK

engineers project management planners

30 west gude suite 120 rockville maryland 20850

Date
10-06-92

p.o. box 10313 rockville 20849-0313 phone 301 294 6390

SHAK CONSULTANTS, INC.

Designed
H.A.C.

Date
10-06-92

Project No.
92M-8551

92M-8551 9 OF 11 SDP-93-11

Checked

D.A.K.

Scale

1"=20'

Sheet No.

43

